VENTURA COLLEGE DIESEL SHOP

4667 TELEGRAPH ROAD VENTURA, CALIFORNIA 93003

VENTURA COUNTY COMMUNITY COLLEGE DISTRICT

ABBREVIATIONS

EXISTING ARCHITECTURAL CENTER LINE CLEAR **DEMOLITION EQUAL EQUIPMENT EXISTING EXPANSION EXTERIOR** FLOOR DRAIN FIRE EXTINGUISHER FINISH FLOOR FINISH GRADE FACE OF CONCRETE F.S.

FIRE RATED, FIRE RESISTANT FINISHED SURFACE FRAME FOOT OR FEET **GAUGE** GEN **GENERAL GYPSUM HOLLOW METAL** HARDBOARD HEADER HARDWARE HIGH HEIGHT **INCHES** INFORMATION INSULATION

> INTERIOR MAXIMUM MINIMUM

ROOM

WITH

NOT TO SCALE ON CENTER

SQUARE FEET

VERIFY IN FIELD

WHERE OCCURS

REFLECTED CEILING PLAN

UNLESS NOTED OTHERWISE

DRAWING INDEX

GENERAL
G001 TITLE SHEET

G002 GENERAL & ACCESSIBILITY NOTES & CODE ANALYSIS

ARCHITECTURAL
A100 CAMPUS SITE PLAN

A101 SITE PLAN

A102 FLOOR PLAN - DEMOLITION

A103 FLOOR PLAN - NEW CONSTRUCTION

A501 DETAILS

STRUCTURAL
S001 GENERAL NOTES & TYPICAL DETAILS

S103 KEY PLAN & STRUCTURAL DETAILS

ELECTRICAL
E001 ELECTRICAL SPECIFICATIONS

E0201D ELECTRICAL POWER PLAN - DEMOLITION

E201 ELECTRICAL POWER PLAN - NEW

E301 ELECTRICAL DETAILS

Grand total: 14

SUMMARY OF SCOPE OF WORK

DEMOLISH AND DISPOSE OF FOUR EXISTING EXTERIOR AUTO LIFTS.
 DEMOLISH AND DISPOSE OF EXISTING CONCRETE PAVING.
 DEMOLISH AND DISPOSE OF EXISTING ASPHALT PAVING.
 DISCONNECT AND PROTECT POWER FEEDS TO FOUR EXISTING AUTO LIFTS.
 CONSTRUCT REINFORCED CONCRETE FOOTINGS AND CONCRETE PAVING.
 PATCH AND SEAL ASPHALT PAVING AT PERIMETER OF CONCRETE.
 INSTALL FIVE NEW AUTO LIFTS.
 CONNECT TO FOUR EXISTING POWER SOURCES.
 PROVIDE ONE NEW POWER SOURCE.

DESIGN TEAM

AMADOR

amador whittle architects, inc. 28328 AGOURA ROAD, SUITE 203 AGOURA HILLS, CA 91301 (805) 530-3938


STRUCTURAL ENGINEER ORION STRUCTURAL GROUP, INC. 223 E. THOUSAND OAKS BLVD. #220 THOUSAND OAKS, CA 91360


ELECTRICAL BUDLONG & ASSOCIATES


(805) 390-9242


1000 PASEO CAMARILLO, SUITE 140 CAMARILLO, CALIFORNIA 93010 (805) 987-4001

<u>LEGEND</u>

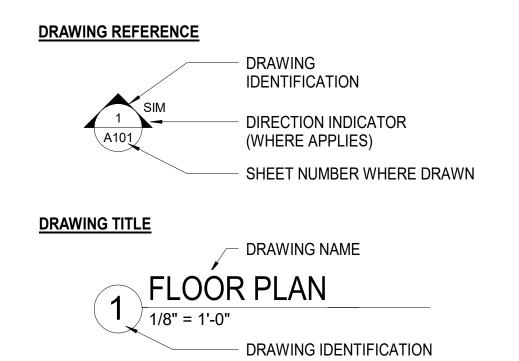


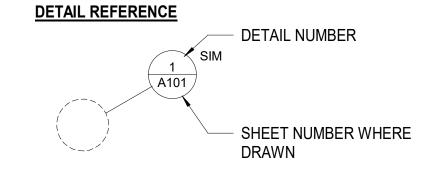


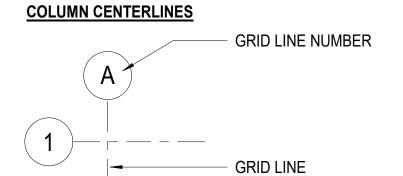

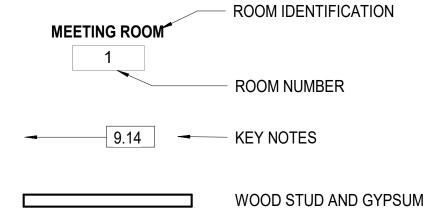


BOARD WALL

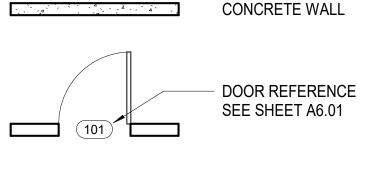

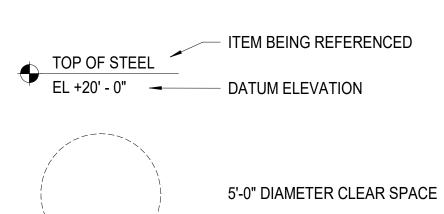

1t - WINDOW REFERENCE

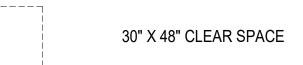

APPLICABLE CODES

LIST OF 2022 CALIFORNIA CODE OF REGULATIONS (C.C.R.):
APPLICABLE CODES AS OF JANUARY 1, 2023

PART 1- 2022 CALIFORNIA BUILDING STANDARDS ADMINISTRATIVE CODE, TITLE 24 C.C.R.

PART 2- 2022 CALIFORNIA BUILDING CODE, TITLE 24 C.C.R.

WITH CALIFORNIA AMENDMENTS)

PART 3- 2022 CALIFORNIA ELECTRICAL CODE, TITLE 24 C.C.R.

(2018 INTERNATIONAL BUILDING CODE OF THE INTERNATIONAL CODE COUNCIL,

(2017 NATIONAL ELECTRICAL CODE AND 2019 CALIFORNIA AMENDMENTS)

2022 CALIFORNIA MECHANICAL CODE, TITLE 24 C.C.R.

PART 4(2018 UNIFORM MECHANICAL CODE OF THE INTERNATIONAL ASSOCIATION OF

PLUMBING AND MECHANICAL OFFICIALS, IAPMO AND 2019 CALIFORNIA AMENDMENTS)

PART 5- 2022 CALIFORNIA PLUMBING CODE, TITLE 24 C.C.R.

(2018 UNIFORM PLUMBING CODE OF THE INTERNATIONAL ASSOCIATION OF PLUMBING AND MECHANICAL OFFICIALS, IAPMO)

PART 6- 2022 CALIFORNIA ENERGY CODE, TITLE 24 C.C.R.

CURRENTLY VACANT

TITLE 24 C.C.R.


PART 8- CURRENTLY VACANT

PART 9- 2022 CALIFORNIA FIRE CODE, TITLE 24 C.C.R. (2018 INTERNATIONAL FIRE CODE OF THE INTERNATIONAL CODE COUNCIL)

PART 102022 CALIFORNIA EXISTING BUILDING CODE (2018 INTERNATIONAL EXISTING BUILDING CODE OF THE INTERNATIONAL CODE COUNCIL, WITH AMENDMENTS)

PART 112022 CALIFORNIA GREEN BUILDING STANDARDS CODE (CALGREEN CODE),

PART 12- 2022 CALIFORNIA REFERENCE STANDARDS CODE, TITLE 24 C.C.R.

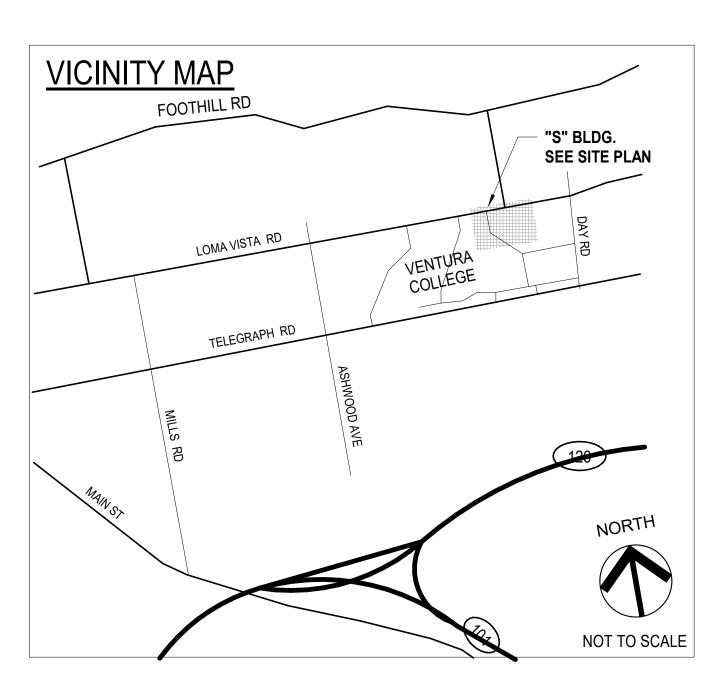



DIVISION OF THE STATE ARCHITECT

VENTURA COUNTY COMMUNITY COLLEGE DISTRICT

761 EAST DAILY DRIVE CAMARILLO, CALIFORNIA 93010 TEL: (805) 652-5500

PROJECT TITLE AND SCHOOL LOCATION

24-VCCCD-018- REPLACE AUTO LIFTS AT WAM


4667 TELEGRAPH RD. VENTURA, CA 93003

COMMISSIONED ARCHITECT

AMADOR

amador whittle architects, inc.
28328 AGOURA RD, 203 | AGOURA HILLS CA, 91301 | 805-530-3938

CONSULTANT

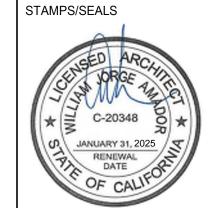

SHEET TITLE:

TITLE SHEET

PROJECT NO. 24-VCCCD-018 PROJECT ARCH: WJA

G001

08/09/2024

____ OF ___

GENERAL NOTES

1. INTERPRETATION OF CONSTRUCTION DOCUMENTS A. ALL INFORMATION DEPICTED IN THESE DRAWINGS AND RELATIVE TO EXISTING CONDITIONS IS BASED ON THE BEST AVAILABLE DATA AT THE TIME THESE CONSTRUCTION DOCUMENTS WERE BEING EXCECUTED, BUT WITHOUT GUARANTEE OF ACCURACY. CONTRACTOR SHALL VERIFY ALL DIMENSIONS AND CONDITIONS AT JOB SITE AND SHALL REPORT ANY DISCREPANICES TO ARCHITECT PRIOR TO COMMENCING ANY

B. THE CONTRACTOR IS RESPONSIBLE FOR ALL COSTS INCURRED RESULTING FROM THE REMOVAL OR REPLACEMENT OF WORK INSTALLED WITHOUT PROPER COORDINATION TO ALL OTHER TRADES, AND/OR PRIOR TO OBTAINING CLARIFICATION FROM THE ARCHITECT WHERE CONFLICTING INFORMATION EXISTS ON THE DRAWINGS.

C. THE CONTRACTOR SHALL FURNISH ALL BIDDERS WITH A COMPLETE SET OF CONSTRUCTION DOCUMENTS. INCLUDING BUT NOT LIMITED TO DRAWINGS. SPECIFICATIONS AND ADDENDUMS.

D. ALL BIDS AND LINE ITEM COSTS SUBMITTED BY THE CONTRACTOR IN CONJUNCTION WITH HIS SUBCONTRACTORS ARE CONSIDERED TO INCLUDE COMPLETE COORDINATION BETWEEN THE VARIOUS DISCIPLINES AS WELL AS ALL OTHER REQUIREMENTS OF THESE CONSTRUCTION DOCUMENTS, INCLUDING BUT NOT LIMITED TO CODE AND PUBLIC UTILITY REQUIREMENTS. FURTHER, WHERE THERE ARE CONFLICTING SOLUTIONS IN THE CONSTRUCTION DOCUMENTS AND BID OR LINE ITEM COST IS SUBMITTED BY THE CONTRACTOR WITHOUT ANY FORMAL WRITTEN REQUEST FOR CLARIFICATION PRIOR TO BID OPENING, ALL SUCH ITEMS WILL BE CONSIDERED TO INCLUDE THE MOST EXPENSIVE OF THE POSSIBLE SOLUTIONS DEPICTED IN THE CONSTRUCTION DOCUMENTS.

E. MODIFICATIONS OF DETAILS OF CONSTRUCTION SHALL NOT BE MADE WITHOUT WRITTEN APPROVAL OF THE ARCHITECT.

- 2. CONTRACTOR SHALL VISIT THE SITE TO INVESTIGATE AND VERIFY ALL DIMENSIONS AND EXISTING SITE CONDITIONS AT JOB SITE PRIOR TO START OF WORK.
- ALL DIMENSIONS INDICATED ARE BELIEVED TO BE ACCURATE, BUT ARE NOT GUARANTEED TO BE SO. CONTRACTOR SHALL FIELD VERIFY ALL DIMENSIONS AND REPORT ANY DISCREPANCIES TO THE ARCHITECT. COORDINATE WITH EXISTING CONDITIONS WHERE INSUFFICIENT DETAIL DIMENSIONS ARE AVAILABLE. ALL DIMENSIONS ARE TO FINISHED FACE OF CONSTRUCTION OR CENTERLINE OF COLUMNS UNLESS NOTED OTHERWISE. DIMENSIONS NOTED AT "CLR" (CLEAR) ARE NOT ADJUSTABLE WITHOUT ARCHITECT'S APPROVAL.
- 4. DIMENSIONS SHOWN SHALL HAVE PREFERENCE OVER SCALE.
- 5. ALL ITEMS INCLUDING BUILDINGS SHOWN ARE EXISTING UNLESS NOTED AS NEW (N).
- CONTRACTOR SHALL TAKE ALL PRECAUTIONARY MEASURES TO PROTECT EXISTING PIPELINES AND UTILITIES THAT ARE TO REMAIN IN SERVICE. CONTRACTOR SHALL VERIFY THAT THOSE PIPELINES AND UTILITIES TO BE REMOVED HAVE BEEN DISCONNECTED. SHUT DOWN OR ABANDONED PRIOR TO ATTEMPTING REMOVAL OR DEMOLITION IN A MANNER TO AVOID ANY DISRUPTION OF EXISTING FACILITIES.
- 7. CONTRACTOR SHALL PROTECT ALL SURFACES & FIXTURES TO REMAIN DURING DEMOLITION AND CONSTRUCTION.
- 8. ALL DAMAGE DONE TO EXISTING CONSTRUCTION AS A RESULT OF DEMOLITION OR INSTALLATION SHALL BE COMPLETELY REPAIRED BY CONTRACTOR AT OR NO COST TO OWNER. REPAIRED WORK SHALL MATCH EXISTING CONSTRUCTION.
- 9. CONTRACTOR SHALL REPAIR AND PATCH UP ALL DAMAGES TO EXISTING SURFACES CAUSED BY REMOVAL OF EXISTING EQUIPMENT ATTACHED TO EXISTING SURFACES. (CHALKBOARDS, BOOKSHELVES, TACKBOARDS, WALL HEATERS, PIPING, ETC.)
- 10. WHERE PATCHES ARE REQUIRED IN EXISTING. SURFACES ADJACENT MATERIAL SHALL BE MATCHED IN TEXTURE AND FINISH.
- 11. "DEMOLISH" AND "REMOVE" SHALL MEAN TO DEMOLISH, REMOVE FROM THE SITE AND DISPOSE OF IN A LEGAL MANNER UNLESS NOTED OTEHRWISE. TERMINATE PIPING BELOW SUBSTRATE FOR PATCHING. ELECTRICAL WIRE DISCONNECT SHALL BE AT THE SOURCE OF POWER.
- 12. SALVAGED PRODUCTS SAVED FOR OWNER AS A RESULT OF DEMOLITION ACTIVITY AND/OR PRODUCTS STORED FOR USE IN CONSTRUCTION SHALL BE STORED IN A MANNER SUCH THAT NO MATERIALS ARE DAMAGED AND PUBLIC SAFETY IS MAINTAINED.
- 13. CONTRACTOR SHALL THOROUGHLY CLEAN AND SECURE THE AREA OF CONSTRUCTION AFTER EACH DAY OF WORK. CONTRACTOR SHALL REMOVE AND DISPOSE OF ALL CONSTRUCTION DEBRIS OFF SITE.
- 14. LOCATIONS OF STRUCTURES, UNDERGROUND PIPELINES AND UTILITIES WERE OBTAINED FROM AVAILABLE RECORDS. THE CONTRACTOR SHALL FIELD VERIFY THE LOCATIONS AND ELEVATIONS OF ALL PIPELINES AND UTILITIES BEFORE COMMENCING DEMOLITON, EARTHWORK OR CONSTRUCTION WORK.
- 15. GENERAL CONTRACTOR SHALL VERIFY ALL SITE CONDITIONS PRIOR TO START OF CONSTRUCTION. ALL QUESTIONS SHALL BE SENT TO ARCHITECT.
- 16. ALL SALVAGEABLE MATERIALS AND EQUIPMENT TO BE REMOVED SHALL REMAIN THE SOLE PROPERTY OF THE OWNER. THE CONTRACTOR SHALL CONSULT WITH THE OWNER CONCERNING STORAGE AND/OR DISPOSAL OF SUCH EQUIPMENT. OWNER HAS FULL SALVAGE RIGHTS. ALL REMOVED MATERIALS OTHER THAN ITEMS TO BE SALVAGED, OR REUSED SHALL BECOME CONTRACTOR'S PROPERTY AND SHALL BE REMOVED FROM THE PROJECT SITE.
- 17. ALL WORK, INCLUDING REMOVAL OF EXISTING WORK, SHALL BE PERFORMED IN A MANNER THAT MINIMIZES THE AMOUNT OF NOISE, DUST, TRAFFIC AND/OR OTHER FORMS OF DISTURBANCES IN COMPLIANCE WITH ALL APPLICABLE CODES AND ORDINANCES SO THAT THE PUBLIC, STUDENTS AND STAFF, AS WELL AS OTHER OCCUPIED AREAS OF THE SCHOOL ARE SUBJECTED TO AS LITTLE DISRUPTION AS REASONABLY POSSIBLE.
- ROUTES OF INGRESS AND EGRESS FOR MATERIALS AND WORKMEN, AND LIMITS OF THE PROJECT AREA WILL BE DESIGNATED BY THE OWNER. THE CONTRACTOR SHALL CONFINE HIS ACTIVITES WITHIN SUCH LIMITS. THE CONTRACTOR SHALL INSTALL AND MAINTAIN ADEQUATE SAFETY AND DUST BARRIERS IN THE SITE, ACROSS CORRIDORS AND ELSEWHERE AS REQUIRED.
- 19. SHUT DOWN OF EXISTING AND OPERATING PLUMBING, MECHANICAL AND ELECTRICAL SYSTEMS OR PORTIONS THEREOF SHALL BE COORDINATED IN ADVANCE WITH THE

- 20. CONTRACTOR SHALL COORDINATE ALL WORK SHOWN ON THE ARCHITECTURAL DRAWINGS WITH THE SPECIFICATIONS AND THE WORK SHOWN ON THE MECHANICAL. PLUMBING. AND ELECTRICAL DRAWINGS. ANY DISCREPANCIES FOUND SHALL BE BROUGHT TO THE ATTENTION OF THE ARCHITECT IN WRITIING BEFORE PROCEEDING WITH ANY RELATED WORK.
- CONTRACTOR SHALL BE RESPONSIBLE FOR THE FIRE RATING CONTINUITY OF STRUCTURE, WALLS, FLOOR AND CEILINGS INTERRUPTED BY THE WORK OF ALL TRADES. THIS INCLUDES, BUT IS NOT LIMITED TO, FIRE RATED ENCLOSURES AT THE CEILING AND WALLS OF CORRIDORS AND STORAGE ROOMS, DUCT SHAFTS.
- PROVIDE ALL NECESSARY BLOCKING, BACKING AND FRAMING FOR LIGHT FIXTURES, ELECTRICAL UNITS, A/C EQUIPMENT, TOILET FIXTURES & ACCESSORIES, RAILINGS, GRAB BARS, AND ALL OTHERS REQUIRING SAME.
- 23. CEILING HEIGHT DIMENSIONS ARE FROM FINISH FLOOR TO FINISH FACE OF CEILING.
- 24. WHERE NEW WALLS ALIGNS WITH EXISTING WALL, PROVIDE SMOOTH INVISIBLE TRANSITION BETWEEN NEW AND EXISTING.
- 25. NEW GYPSUM BOARD FINISH SHALL BE 5/8" TYPE 'X' OR AS REQUIRED FOR UL FIRE-RATING AS INDICATED ON DRAWINGS.
- 26. GENERAL CONTRACTOR SHALL PROVIDE TEMPORARY EIGHT (8) FEET HIGH CHAIN LINK FENCE BARRICADES AT WORK AREAS, DISTRICT APPROVED STORAGE AREAS AND WHEREVER NECESSARY TO MAINTAIN A SAFE PASSAGE AND SAFE ENVIRONMENT.
- BEFORE PROCEEDING WITH THE CORING OR CUTTING OF WALLS AND FLOORS, ETC., THE CONTRACTOR SHALL PREPARE LAYOUT OF CUTTING OR CORING AND SHALL HAVE THE APPROVAL BY THE STRUCTURAL ENGINEER IN ORDER TO PROCEED WITH THE CUTTING OR CORING.
- 28. A) SLABS ON EARTH, SIDEWALKS AND CURBS: 3,000 PSI AT 28 DAYS
- 29. B) FOUNDATIONS: 3,000 PSI AT 28 DAYS
- 30. THE CONTRACTOR SHALL NOT COMMENCE THE WORK, IN PART OR IN FULL, PRIOR TO OBTAINING THE NOTICE-TO-PROCEED (NTP) FROM VCCCD.
- 31. IN CASE OF CONFLICT, THE MORE EXPENSIVE CONSTRUCTION MEANS AND METHOD SHALL BE USED.
 - THE PROVISIONS OF CFC CHAPTER 14 AND CBC CHAPTER 33 SHALL BE ENFORCED ON THIS PROJECT.





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PROJECT TITLE AND SCHOOL LOCATION

24-VCCCD-018- REPLACE **AUTO LIFTS AT WAM**

4667 TELEGRAPH RD. VENTURA, CA

COMMISSIONED ARCHITECT

amador whittle architects, inc 28328 AGOURA RD, 203 | AGOURA HILLS CA, 91301 | 805-530-393

CONSULTANT

STAMPS/SEALS




SHEET TITLE:

GENERAL & ACCESSIBILITY NOTES & CODE ANALYSIS

PROJECT NO. 24-VCCCD-018 PROJECT ARCH: WJA

SHEET NUMBER:

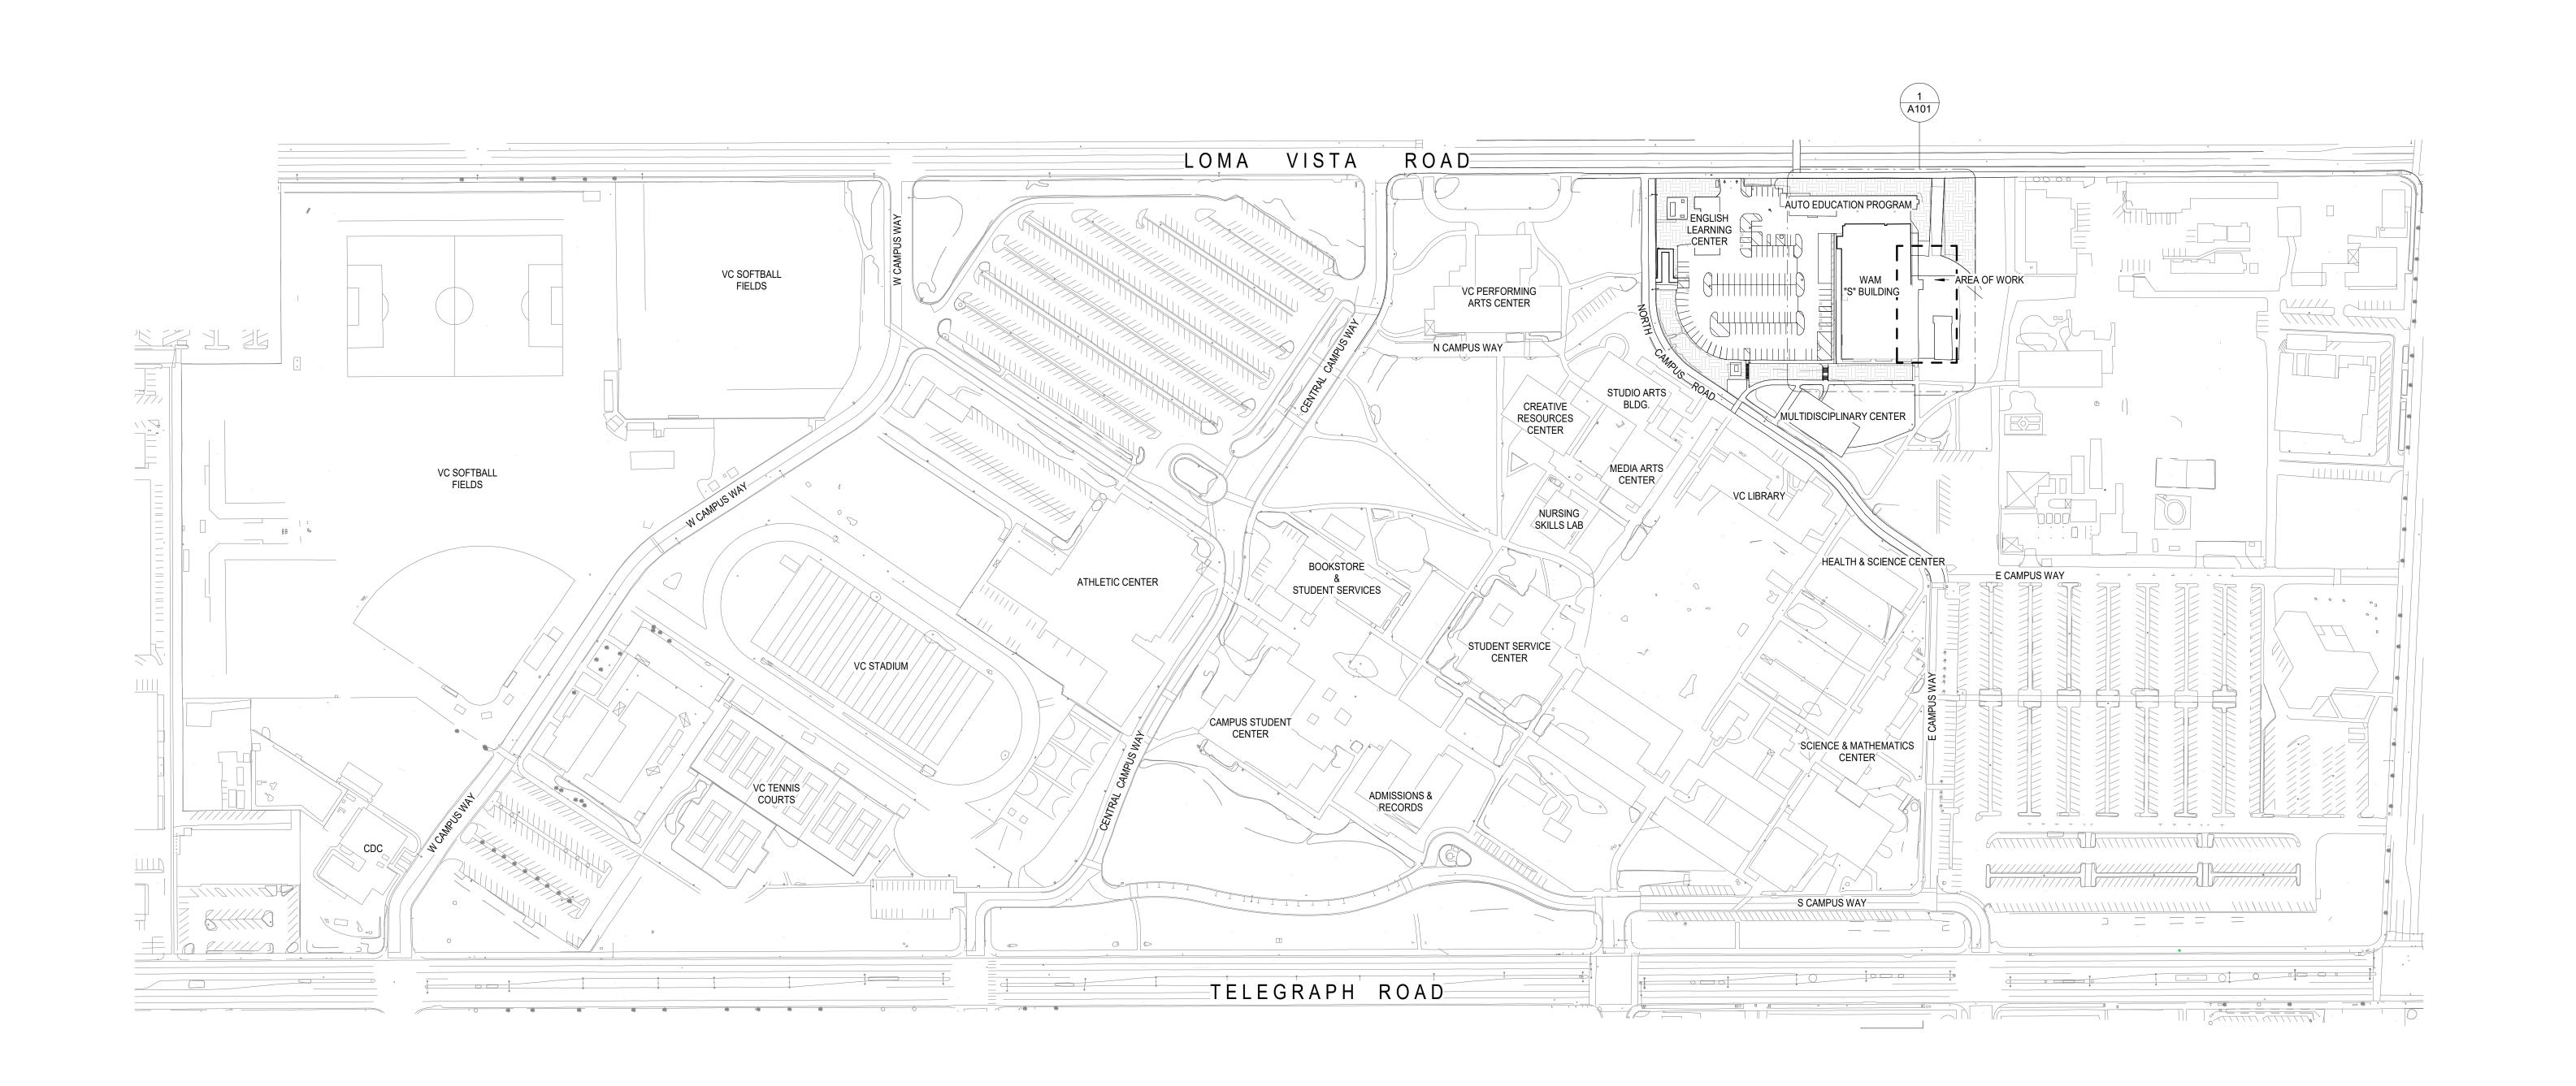

A#15677; 27140

A-14624; A-21069; A-28512

A#11482; 03-110238;

A#11580

A#114511

A#23750

A#39845 A#51118

A#10764; 26943

A# 26592; 23724;

A#104598, 104498

A#23750; 44935; 45630

A#27982; 36633

A#11482

A#60113

A#10623

CERTIFICATE STATUS

APPROVED 01/15/1954

APPROVED 08/04/1965

APPROVED 06/11/1956; 03/09/1961

TR12-15- TRAILER CLASSROOMS

TR 16- NURSING SKILLS LAB

WEC- WRIGHT EVENT CNETER

VCS- VENTURA COLLEGE SPORTSPLEX

VCPD- VENTURA COLLEGE CAMPUS POLICE

A#03-110740 A#03-110740

LEGEND

ADM- ADMINISTRATION
AEC- ATHLETIC EVENT CENTER

ASC- APPLIED SCIENCE CENTER

BLDG S BUILDING S (WAM) C- KINESIOLOGY

DRC- DAY ROAD CENTER

EOP- EOPS

GH- GUTHRIE HALL

HH- HEAD HOUSE

TR 4- CLASSROOM

TECHNOLOGY

AEP- AUTO EDUCATION PROGRAM

CDC- CHILD DEVELOPMENT CENTER

CSC- CAMPUS STUDENT CENTER

ELC- ENGLISH LEARNING CENTER

HSC- HEALTH SCIENCE CENTER

M- CERAMICS & SCULPTURE

MAC- MEDIA ARTS CENTER

NMG- NEW MEDIA GALLERY

SAB- STUDIO ARTS BUILDING

LRC- LEARNING RESOURCE CENTER

M&O- MAINTENANCE & OPERATIONS

PAC- PERFORMING ARTS CENTER

SC- SCIENCES & MATHEMATICS

SSC- STUDENT SERVICES CENTER

MCE- MULTIDISCIPLINARY CENTER EAST -

MCW- MULTIDISCIPLINARY CENTER WEST -

S&R- SHIPPING & RECEIVING/WAREHOUSE -

CRC- CREATIVE RESOURCES CENTER

ECT- ENVIRONMENTAL/CONSTRUCTION

(FORMALLY KNOWN AS DATA PROCESSING UNIT D-P)

BCS- BOOKSTORE & CAMPUS SERVICES

DIVISION OF THE STATE ARCHITECT

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PROJECT TITLE AND SCHOOL LOCATION


24-VCCCD-018- REPLACE **AUTO LIFTS AT WAM**

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AMADÒR

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CAMPUS SITE PLAN 1" = 125'-0"

PROJECT

SHEET TITLE:

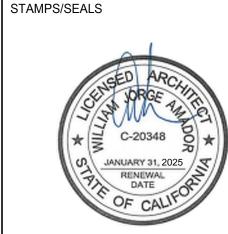CAMPUS SITE PLAN

PROJECT NO. 24-VCCCD-018 PROJECT ARCH: WJA DRAWN: MC Checker

SHEET NUMBER:

08/09/2024 ____ OF ____

NORTH 500'

LOMA VISTA ROAD PLANT AREA PLANT AREA — EXISTING ACCESS ROAD EXISTING AUTO EDUCATION PROGRAM BLDG. STORAGE BIN A-14624 A-21069 A-28512 STORAGE BIN AREA OF WORK -EXISTING 'S' WAM BLDG. A 03-110238 (E) RESTROOMS -(E) RESTROOMS ---PLANT AREA

DIVISION OF THE STATE ARCHITECT



VENTURA COUNTY COMMUNITY COLLEGE DISTRICT

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STAMPS/SEAL



SITE PLAN 1" = 20'-0"

20'-0"

PROJECT NORTH

PROVIDED

PARKING COUNT

ACCESSIBLE PARKING STALL

TOTAL PARKING STALLS

PARKING STALL

ACCESSIBLE VAN PARKING STALL 04

REQUIRED

ACCESSIBLE PATH OF TRAVEL

AREA OF WORK

(E) PIPING LOCATION

(E) LIGHT POLES

<u>LEGEND</u>

1 07-25-23 ADDENDUM 1

SHEET TITLE:

SITE PLAN


PROJECT NO. 24-VCCCD-018 PROJECT ARCH: WJA

DRAWN: MC CHECKED: WJA

A101

AIU |

10' 20' 40' 80'

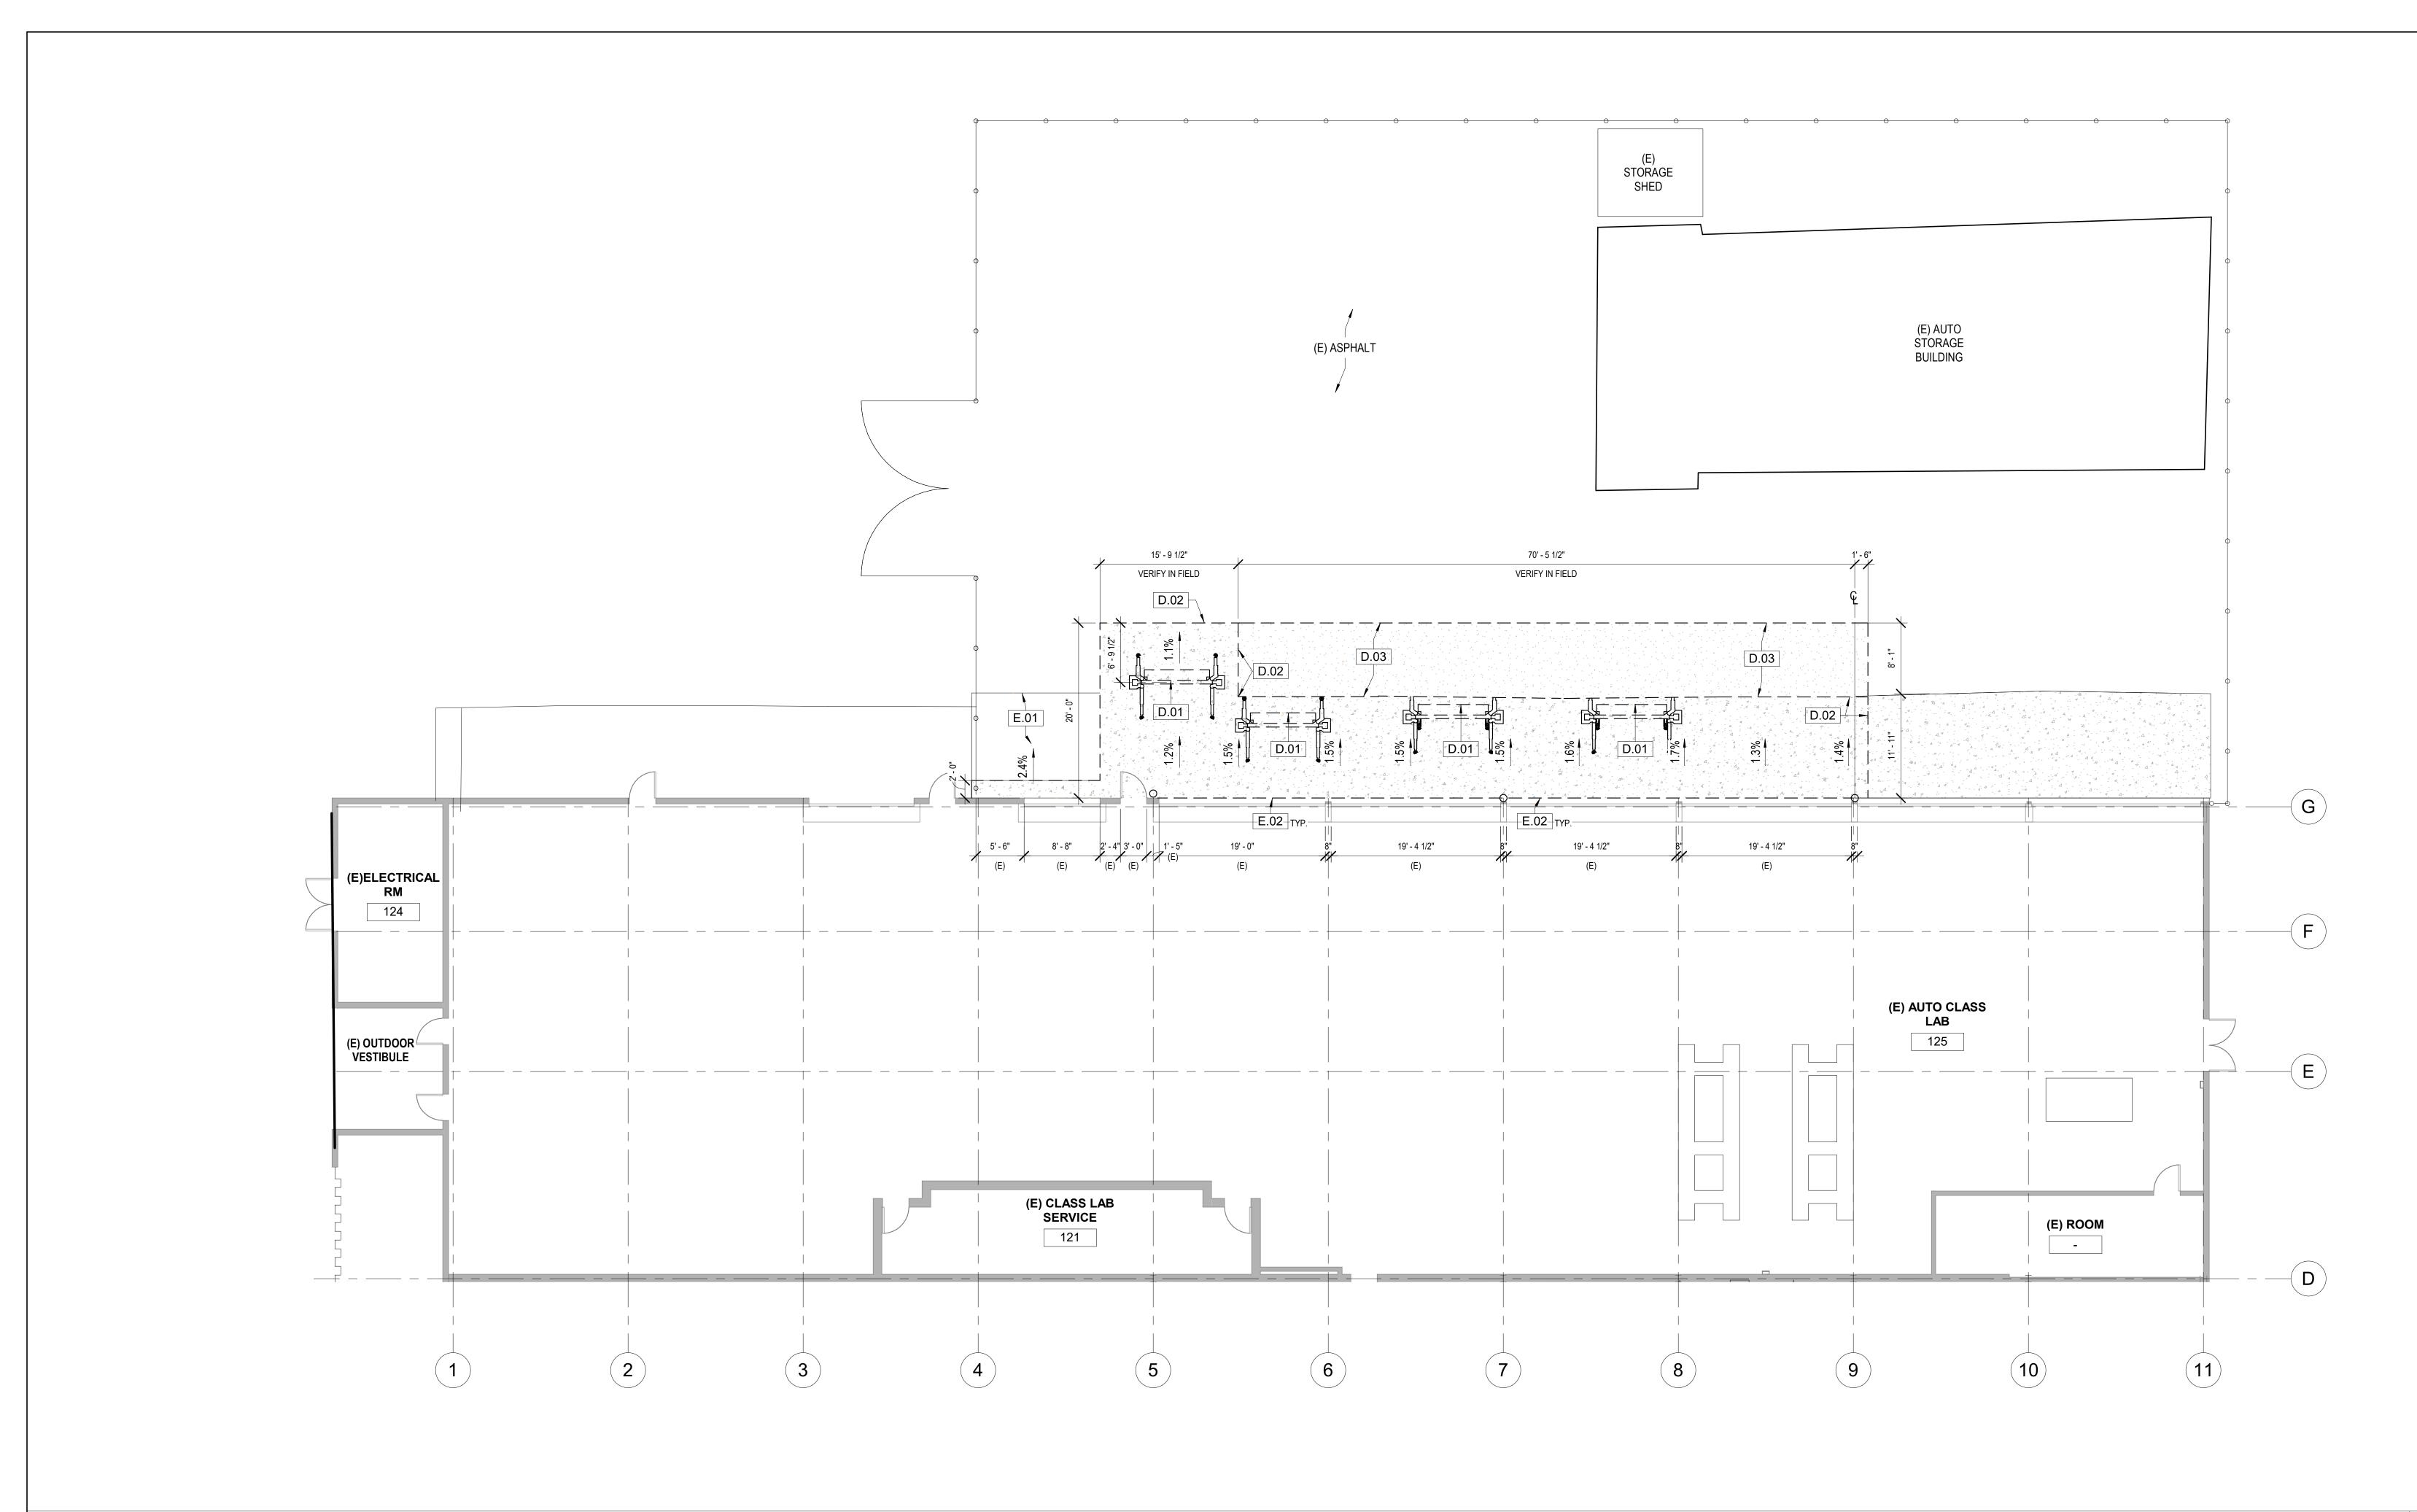

FLOOR PLAN - DEMOLITION 1/8" = 1'-0"

GENERAL NOTES

- 1. ALL ITEMS SHOWN ARE EXISTING UNLESS OTHERWISE NOTED AS NEW.
- DEMOLISH EXISTING POWER CONNECTIONS TO LIFTS AND PREPARE FOR CONNECTION TO NEW LIFTS AS INDICATED ON ELECTRICAL DRAWINGS.

EXISTING KEYNOTES E#

E.01 (E) CONCRETE PAVING TO REMAIN

E.02 PROTECT EDGE OF (E) CONCRETE BUILDING SLAB

DEMOLITION KEYNOTES D#

D.01 DEMOLISH (E) AUTOLIFTS

D.02 SAWCUT PERIMETER AND DEMOLISH (E) REINFORCED CONCRETE.

D.03 SAWCUT PERIMETER AND DEMOLISH (E) 4"ASPHALT PAVING.

LEGEND

_ _ _ _ _ _ (E) FENCE (E) CONCRETE

(E) ASPHALT

WALL LEGEND





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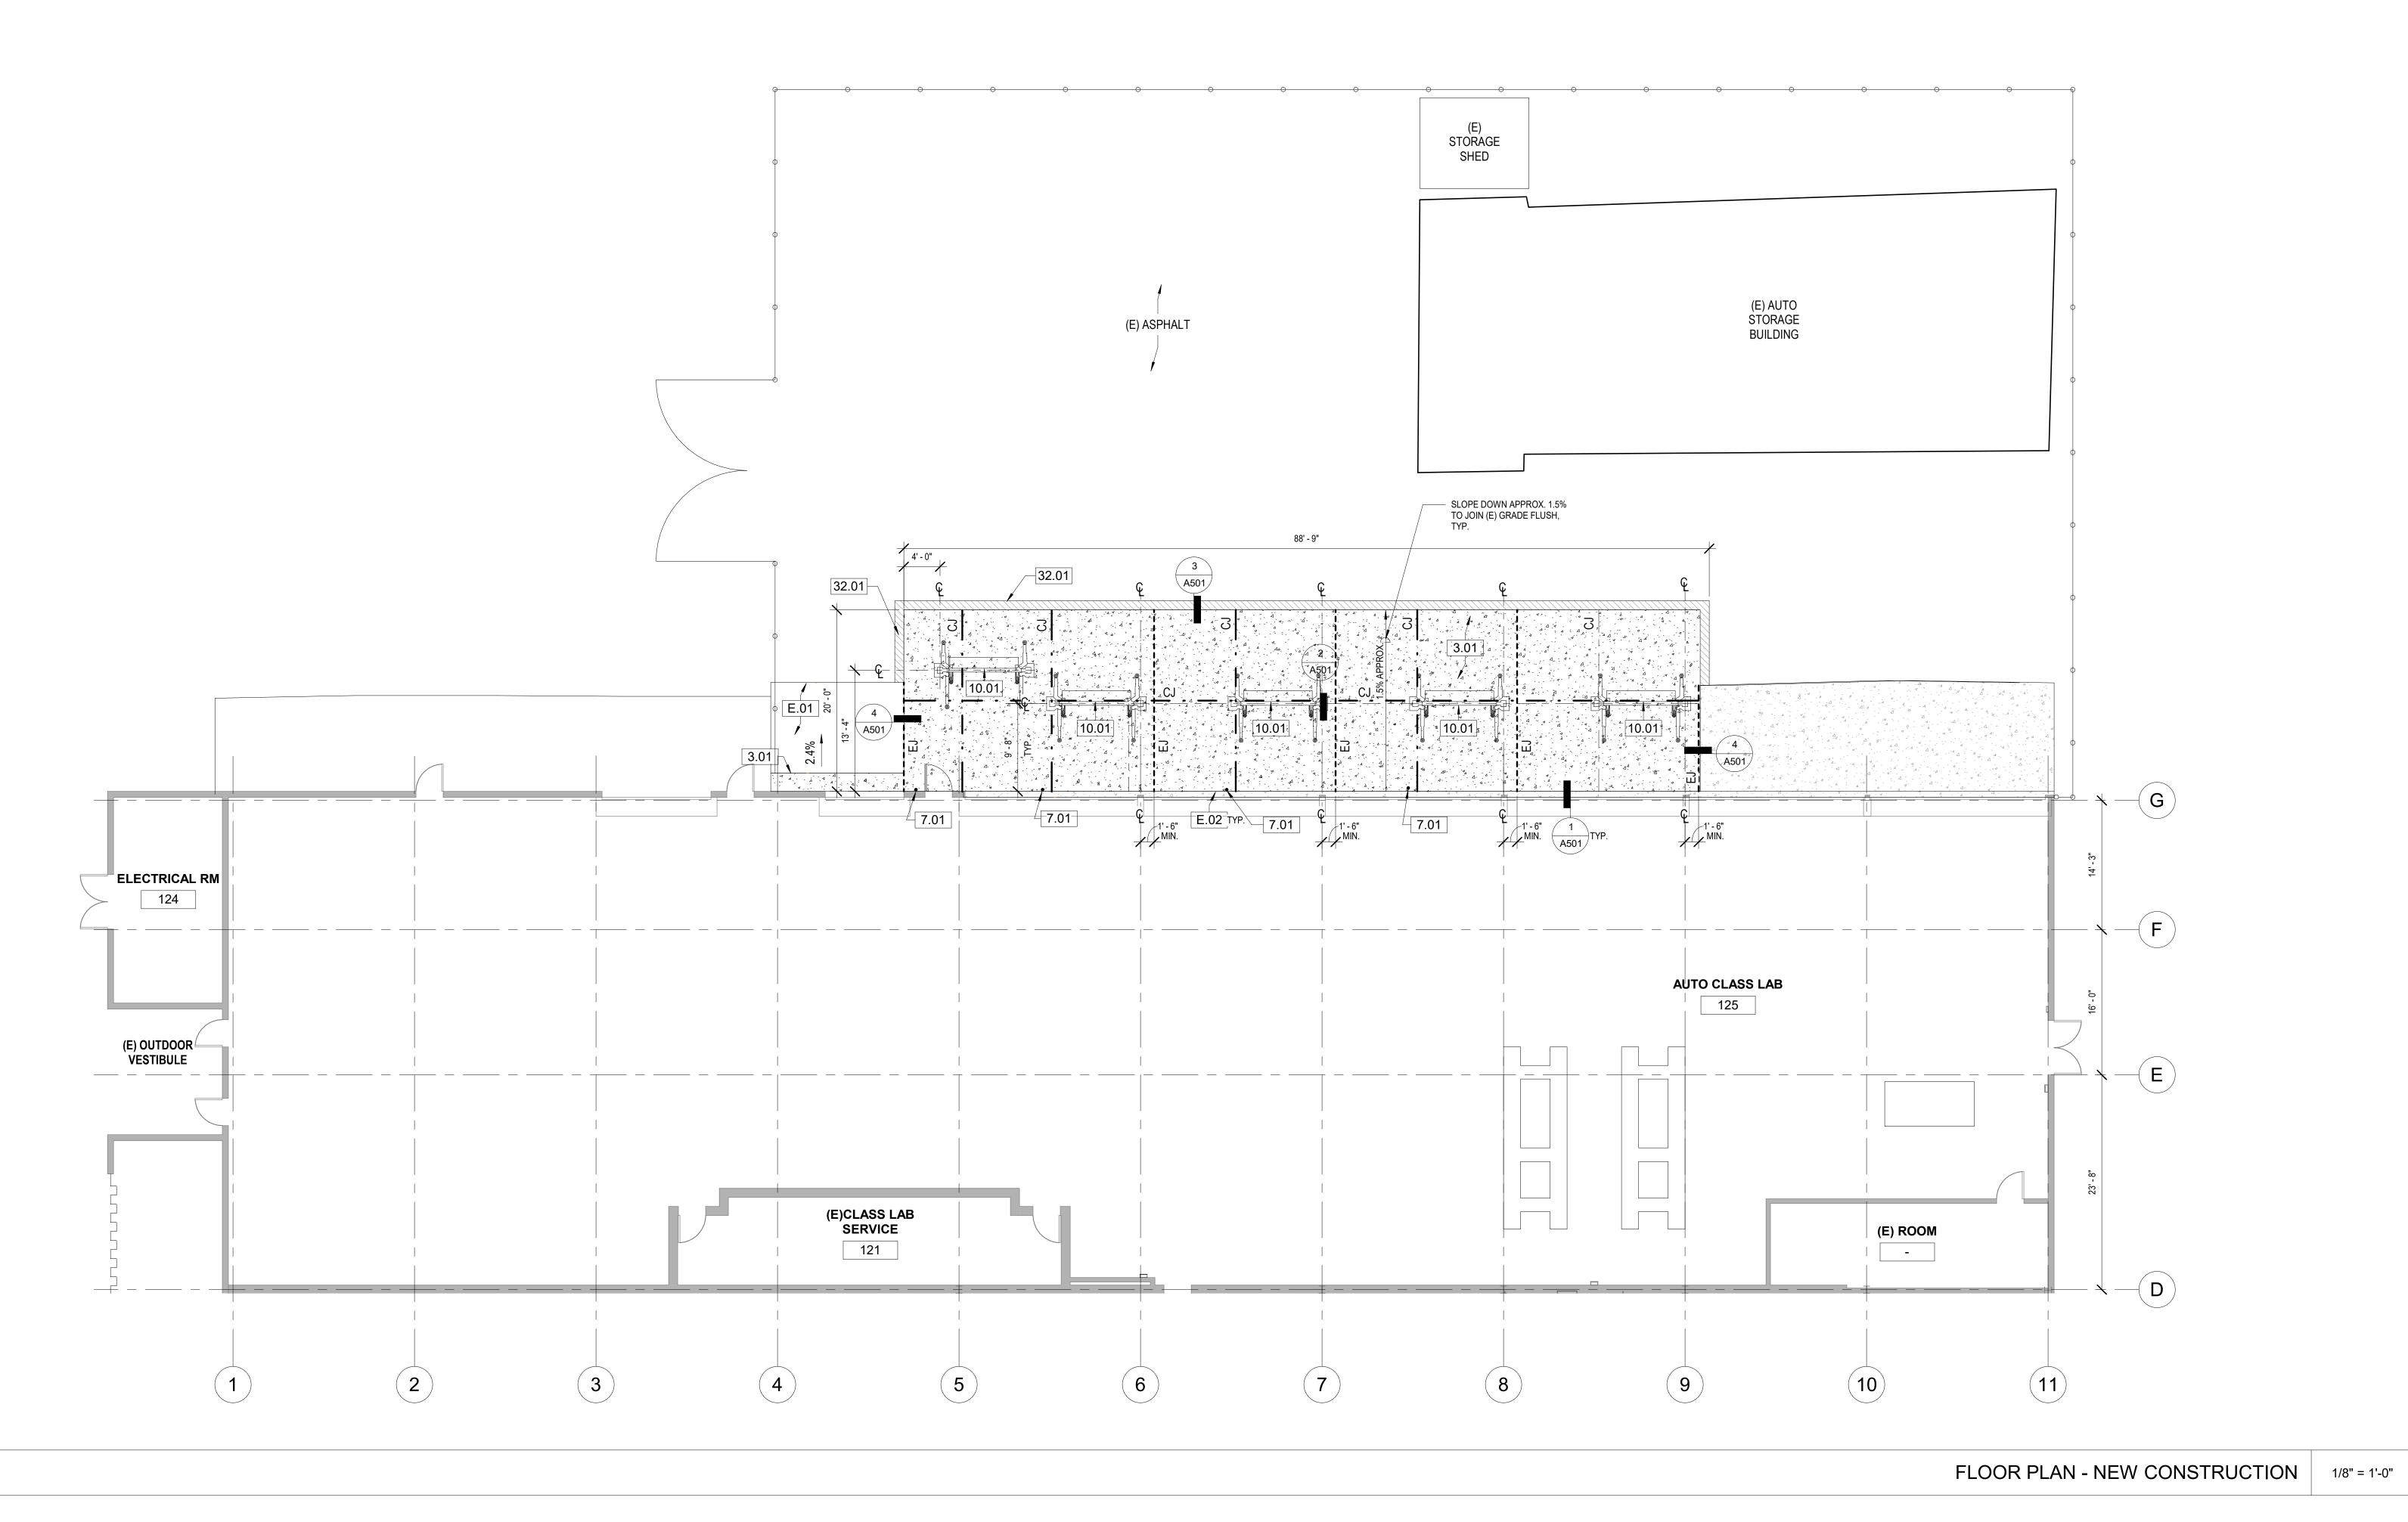
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SHEET TITLE:

FLOOR PLAN -**DEMOLITION**

PROJECT NO. 24-VCCCD-018 PROJECT ARCH: WJA



GENERAL NOTES

- 1. ALL ITEMS SHOWN ARE EXISTING UNLESS OTHERWISE NOTED AS NEW.
- 2. SEE STRUCTURAL FOR AUTO LIFT FOOTINGS.
- 3. SEE ELECTRICAL DRAWINGS FOR POWER CONNECTIONS.

EXISTING KEYNOTES E#

E.01 (E) CONCRETE PAVING TO REMAIN

E.02 PROTECT EDGE OF (E) CONCRETE BUILDING SLAB

KEYNOTES

3.01 (N) 5" CONCRETE PAVING, WITH #4 REBAR AT 16" O.C. EACH WAY. (2) A501

7.01 (N) PROVIDE GALVANIZED PLUG WHERE CONDUIT IS REMOVED, SEAL AND PAINT TO MATCH EXISTING WINDOW FRAMES.

10.01 (N) AUTO LIFT.10AP BENDPAK TWO POST LIFT. RECONNECT TO (E) POWER SOURCE EXCEPT NEW POWER SOURCE FOR SOUTH LIFT.
 32.01 PATCH AND SEAL COAT EDGE OF ASPHALT TO CONCRETE, JOIN FLUSH.

<u>LEGEND</u>

(E) FENCE (E) CONCRETE

WALL LEGEND



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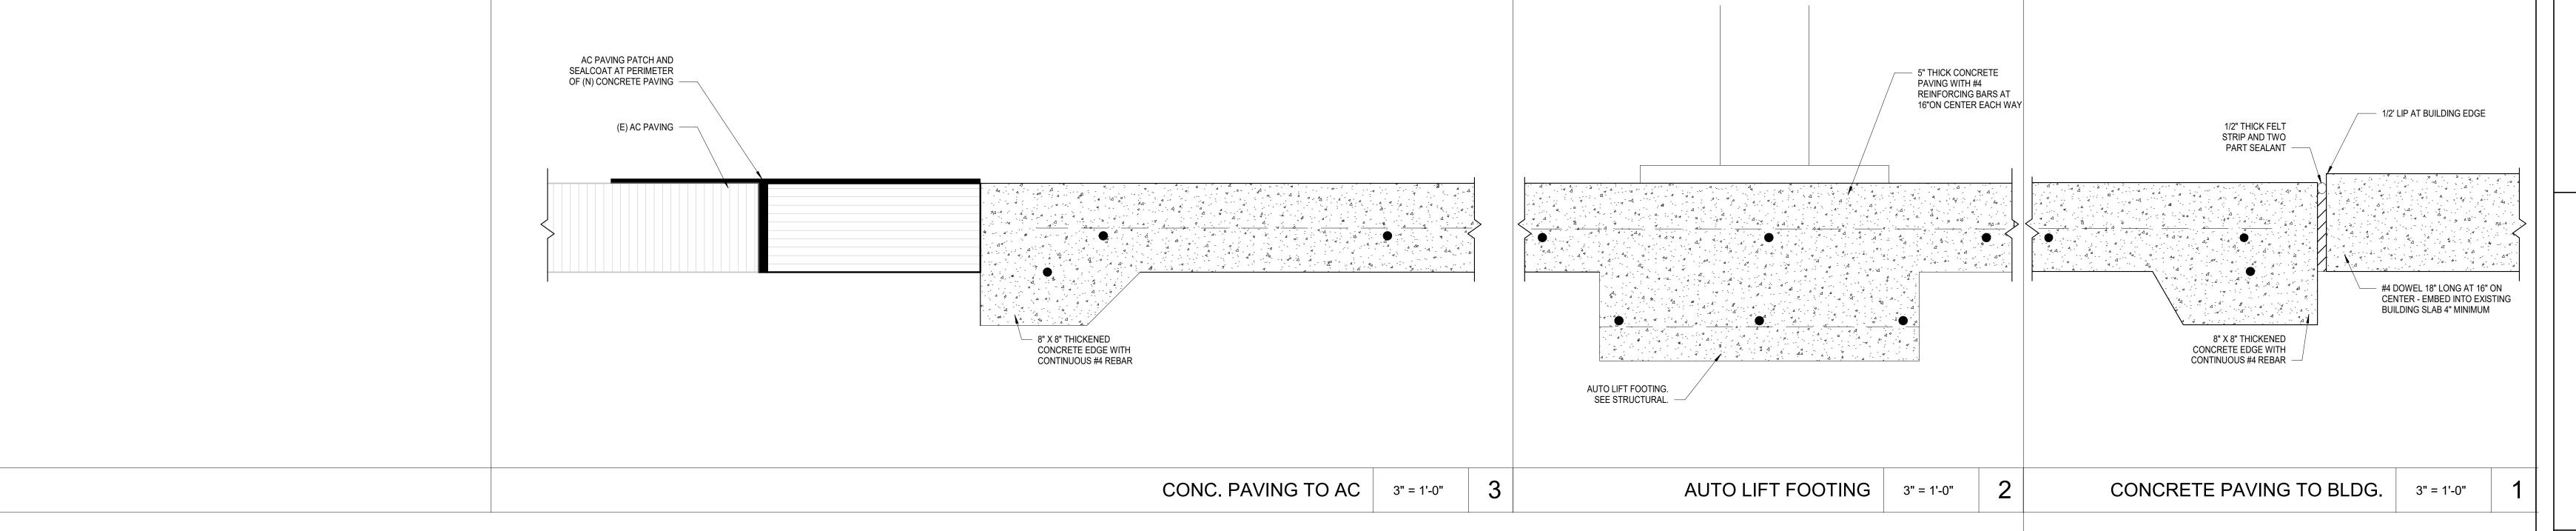
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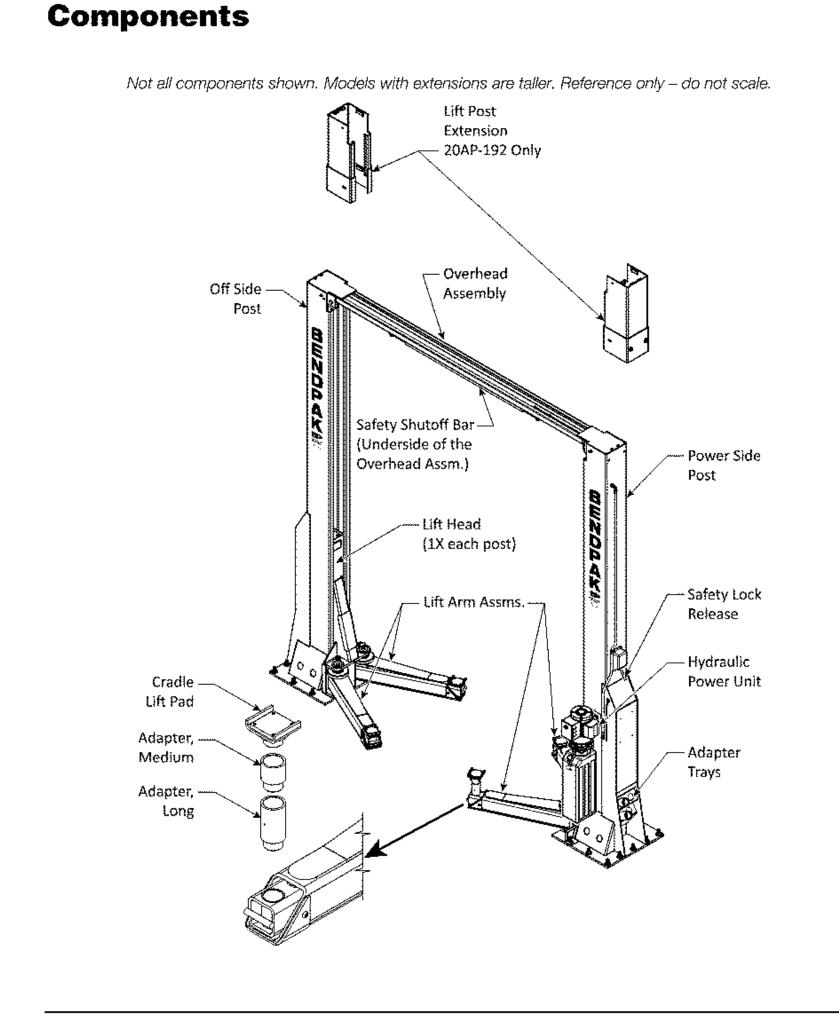
SHEET TITLE:

FLOOR PLAN - NEW CONSTRUCTION

PROJECT NO. 24-VCCCD-018 PROJECT ARCH: WJA








P/N 5900265 — Rev. A10 — September 2023

10AP Series Two-Post Lifts

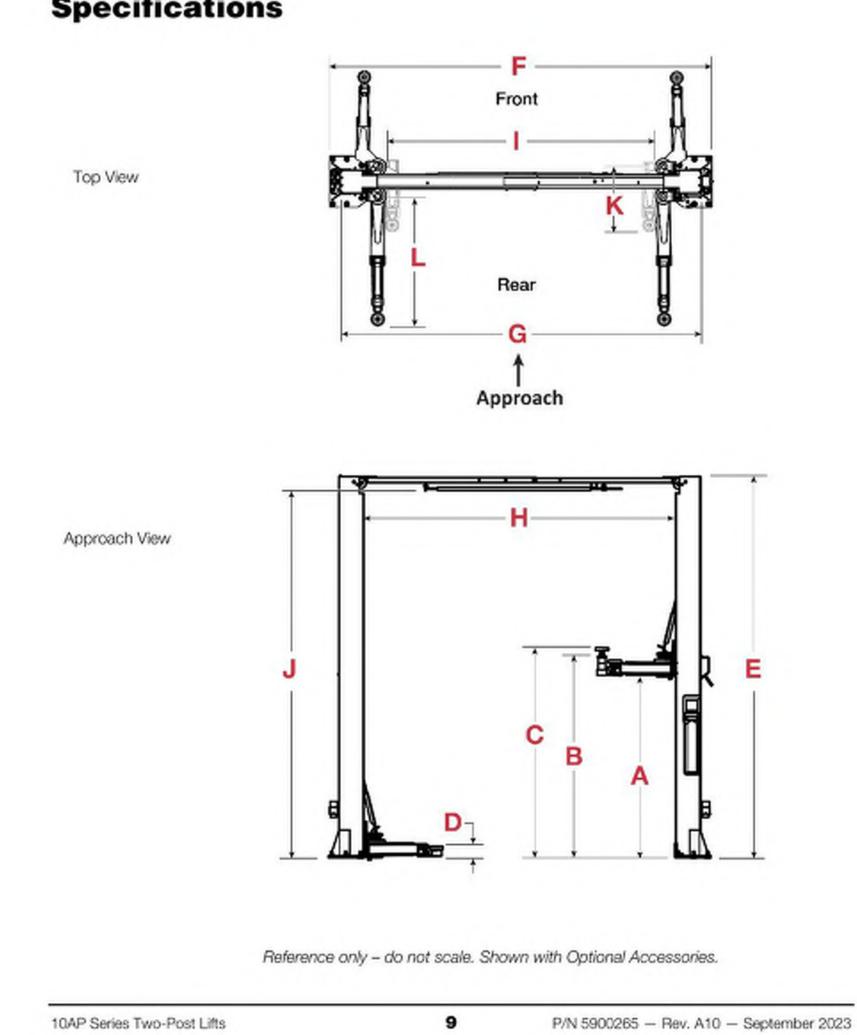

Model	10AP	-10AP-100	10APX									
Lifting Capacity		10,000 lbs.	/ 4,536 kg	•								
Max. Capacity — Front Axie		5,000 lbs. /	/ 2,268 kg									
Max. Capacity — Rear Axle		5,000 lbs. /	2,268 kg									
▲ – Max. Rise	69 in. /	1,753 mm	75.5 hr. / 1,010 mm									
B - Lifting Height w/ Pad*	73 in. /	′ 1;854 mm	79.5 in. / 2,007 mm									
C – Max. Lifting Height ¹	82.5 in,	/ 2,095 mm	= 89 in. / 2,201 marr									
D - Mín, Height w/ Pad		4 in. / 10)2 mm									
E - Overall Height	145 in. / 3,683 mm	= 100 in. / =4,267 mm	167 in. / 0,000 mm	301 in. /								
F – Width Overall (Narrow)		135 in. / 3	431 mm									
F - Width Overall (Wide)		145 in. / 3.	683 mm									
G – Outside Posts (Narrow)		127.5 in. / 3	3,238 mm									
G – Outside Posts (Wide)	137.5 in. / 3,492 mm											
Ħ - Inside Posts (Narrow)		108.5 in. / 2,756 mm										
Ħ − Inside Posts (Wide)	118.5 in. / 3,010 mm											
I – Drive-Thru Width (Narrow)		[92. ln. / 2,	338 mm									
- Drive-Thru Width (Wide)		102 in. 2,	592 mm									
J – Floor to Top Switch	139:5 in: / 3,540 mm	4,155 mm	10 1.5 in.7 175.75 in.7 3,000 min 4,404 min									
K - Front Arm Reach (min)		24.5 in. /	622 mm									
K – Front Arm Reach (max)		50 in. / 1,	270 mm									
L – Rear Arm Reach (min)		·32 in. / 8	12 mm									
L - Rear Arm Reach (max)		.59:25 in. / 1	,504 mm									
Max. load per Lift Arm		2,500 lbs. /	1,134 kg									
Screw Pad Adjustment		2 in. / 5	1 mm									
Time to Full Rise	≈ 45 seconds											
Motor ²		220 VAC, 60	Hz, 1 Phase									
Sound	<70 dB											

Height is maximum lifting height with Pads adjusted to high setting and with both tall and medium Adapters (optional equipment) installed.


*Special voltages available upon request.

*Lift Arms measured from the pivot center to the end of the Lift Arm. Specifications subject to change without notice.


10AP Series Two-Post i	Lifts	10	P/N 5900265 — Rev. A10 — September 2023

	1/2" FELT STRIP WITH TWO PART SEALANT
(E) CONC. PAVING	#4 X 18" LONG REBAR DOWEL AT 16" ON CENTER WITH 4" EMBED INTO (E) CONCRETE
8" X 8" THICKENED CONCRETE EDGE WITH CONTINUOUS #4 REBAR	

CONC. PAVING TO (E) CONC. PAVING 3" = 1'-0"

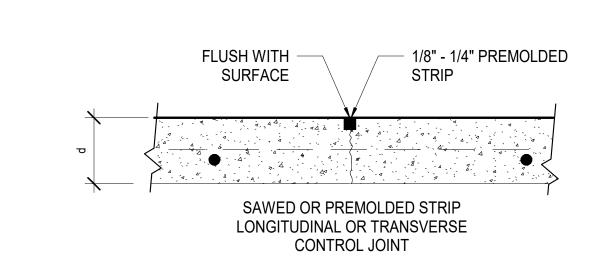

— 1/8" RADIUS **EXPANSION JOINT**

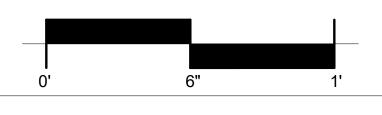

CONCRETE JOINT DETAILS 3" = 1'-0"

DIVISION OF THE STATE ARCHITECT

VENTURA COUNTY COMMUNITY COLLEGE DISTRICT

> 761 EAST DAILY DRIVE CAMARILLO, CALIFORNIA 93010 TEL: (805) 652-5500

PROJECT TITLE AND SCHOOL LOCATION

24-VCCCD-018- REPLACE **AUTO LIFTS AT WAM**

4667 TELEGRAPH RD. VENTURA, CA

COMMISSIONED ARCHITECT

AMADÒR

amador whittle architects, inc. 28328 AGOURA RD, 203 | AGOURA HILLS CA, 91301 | 805-530-3938 CONSULTANT




DETAILS

PROJECT NO. 24-VCCCD-018 PROJECT ARCH: WJA

A501

AUTO LIFT INFO 3" = 1'-0" 6


SHEET TITLE:

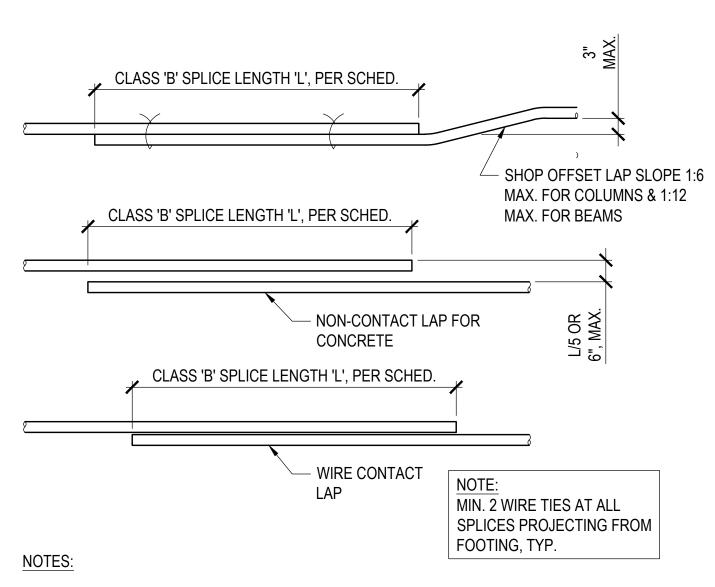

- 1. TOP BARS ARE HORIZONTAL REINFORCING WITH MORE THAN 12" OF CONCRETE BELOW BARS.
- 2. BOTTOM BARS INCLUDE ALL VERTICALS, ALL HORIZONTAL WALL REINFORCING, AND HORIZONTAL REINFORCING WITH LESS THAN 12" OF CONCRETE BELOW BARS.
- 3. A. USE CLASS B SPLICES U.N.O., ADJACENT BAR SPLICES SHALL BE STAGGERED THE GREATER OF THE LENGTH OF SPLICE OR 2'-0".
- B. USE CLASS C SPLICES WHERE NOTED. C. USE CLASS C SPLICES WHERE MORE THAN 49% OF BARS ARE TO BE
- SPLICED IN ONE LOCATION.
- SMALLER BAR LAP LENGTH SHALL BE USED WHEN SPLICING DIFFERENT SIZE BARS. 5. INCREASE SPLICE LENGTH BY 33% FOR LIGHTWEIGHT CONCRETE.


	TENSION LAP SPLICE LENGTH (CLASS B)							DEVELOPMENT LENGTH (Ld) (CLASS A)							
		0 PSI NC fc		0 PSI NC f'c		5000 PSI CONC fc		3000 PSI CONC fc		0 PSI NC f'c	5000 PSI CONC fc				
BAR SIZE	TOP	OTHER	TOP	OTHER	TOP	OTHER	TOP	OTHER	TOP	OTHER	TOP	OTHER			
#3	29	22	28	20	28	20	23	17	21	15	21	15			
#4	39	29	34	25	30	23	30	22	26	19	23	17			
#5	48	36	42	31	38	38 28 3		28	32	24	29	22			
#6	58	43	50	37	45	34	45	33	39	29	35	26			
#7	81	63	71	54	63	49	63	48	54	42	49	38			
#8	93	72	81	62	72	56	72	55	62	48	56	43			
#9	105	81	91	70	81	63	81	62	70	54	63	48			
#10	118	91	102	79	92	70	91	70	79	61	70	54			

#11 | 131 | 101 | 113 | 87 | 102 | 78 | 101 | 78 | 87 | 67 | 78 | 60

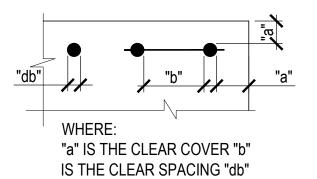


IS THE BAR DIA


- 1. MINIMUM SPLICE LENGTH FOR BARS WITH CLASS 'B' SPLICE PER
- ACI-318-14, SECTION 25.5.
- 2. TOP BARS ARE HORIZONTAL BARS WITH MORE THAN 12" CONCRETE CAST IN THE MEMBER BELOW THE REINFORCEMENT.
- 3. THESE BAR DEVELOPMENT LENGTH APPLY TO REGULAR OR NORMAL WEIGHT CONCRETE,
- MULTIPLY THE SPECIFIED DEVELOPMENT LENGTH BY 1.33 FOR LIGHT WEIGHT CONCRETE. 4. ALL DETAILING OF REINFORCEMENT SHALL COMPLY WITH THESE SCHEDULES UNLESS SPECIFICALLY DETAILED ON THE DRAWINGS.

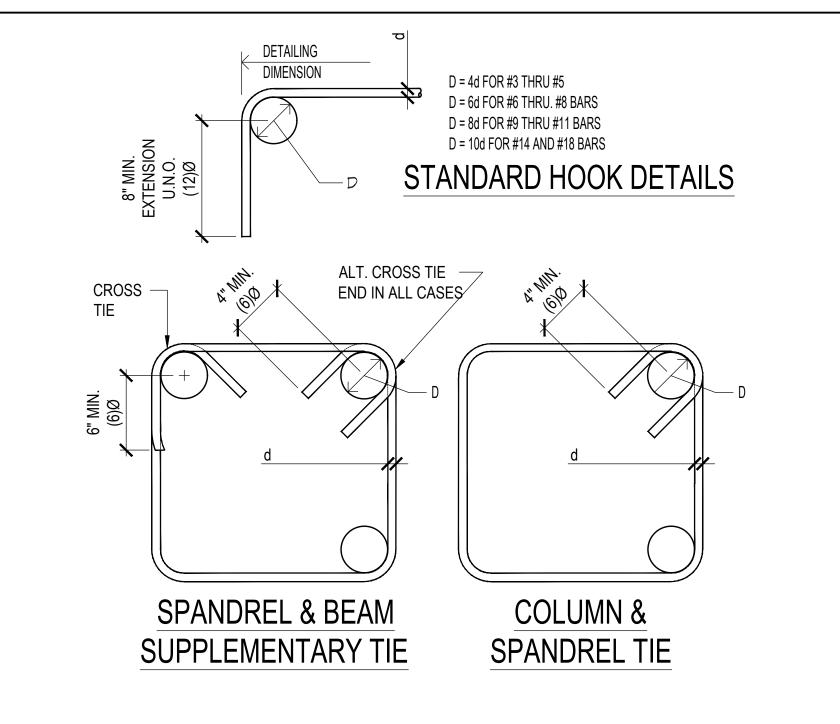



TYP. CONC. REINF. STANDARD HOOK DETAIL SCALE: 1" = 1'-0"

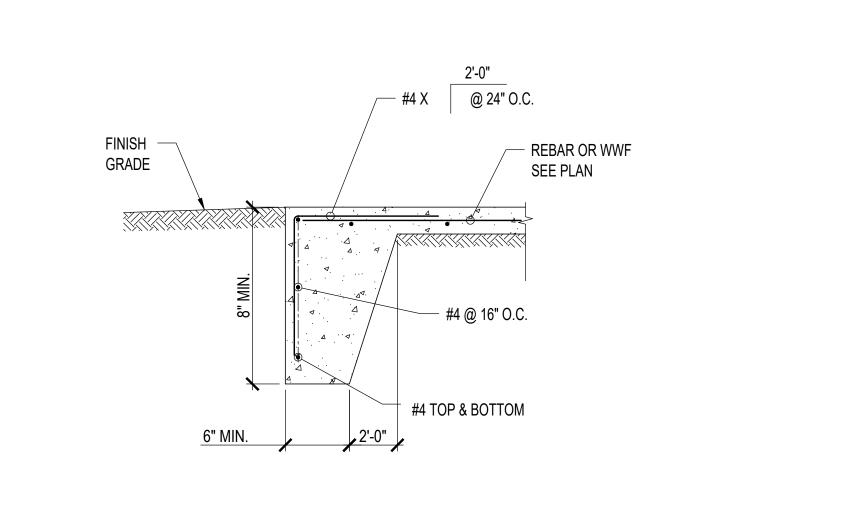

SLAB ON GRADE EDGE DETAIL SCALE: 1" = 1'-0"

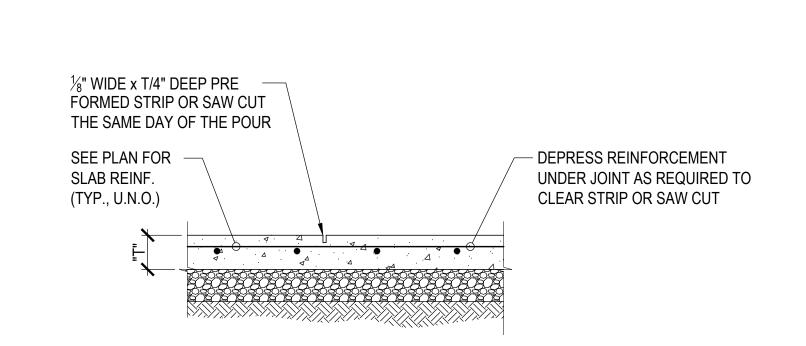

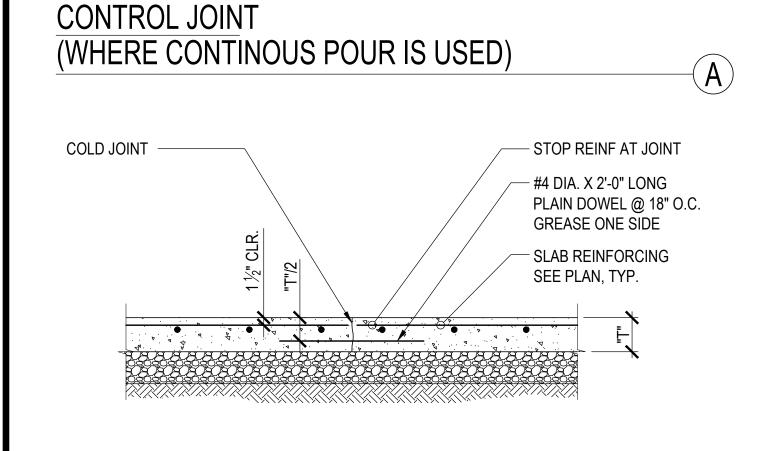

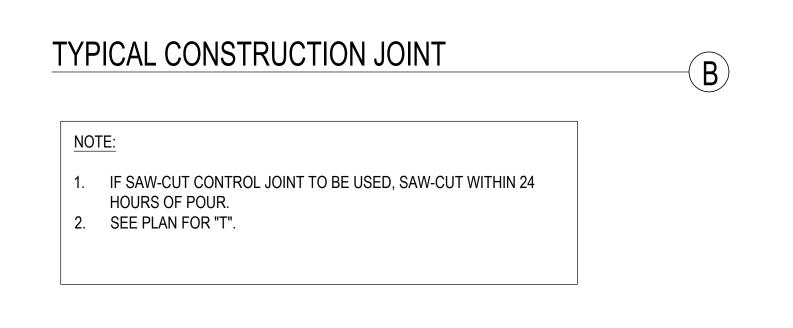

REINFORCEMENT

- 1. ALL TYPICAL REINFORCING BARS SHALL CONFORM TO ASTM A-615, GRADE 60, UNLESS NOTED OTHERWISE ON THE DRAWINGS.
- A. SPIRALS SHALL BE COLD DRAWN BARS CONFORMING TO ASTM A-82. REINFORCING FOR DIAPHRAGMS AND FOUNDATIONS MAY BE GRADE 75 IN LIEU OF GRADE 60. AT THE CONTRACTOR'S OPTION. MAINTAIN OVERALL CAPACITY OF ELEMENTS WHERE GRADE 75 REINFORCING IS PROPOSED FOR USE. IN GENERAL, REDUCE REQUIRED STEEL AREA IN PROPORTION TO RATIO OF YIELD STRENGTH. MAINTAIN BAR SPACING SHOWN ON PLANS, DETAILS, AND SCHEDULES.
- B. MOMENT FRAME LONGITUDINAL REBARS, SHEAR WALL VERTICAL REBARS, AND COUPLING BEAM LONGITUDINAL REBARS SHALL BE ASTM A-706 [Fy=60 KSI]. C. SMOOTH DOWELS IN SLAB ON GRADE: ASTM A36, 36 KSI
- WELDING OF REINFORCEMENT (INCLUDING TACK WELDING) SHALL BE NOT BE DONE UNLESS SPECIFICALLY SHOWN ON THE DRAWINGS. WHERE SHOWN ON THE DRAWINGS, THE FOLLOWING SHALL APPLY:
- A. WELDED REBAR SHALL COMPLY WITH ASTM A-706 [Fy=60 KSI]
- B. WELDING SHALL CONFORM TO AWS D1.4 C. WELDING OF REINFORCING STEEL SHALL BE PERFORMED BY WELDERS CERTIFIED BY
- THE COUNTY OF VENTURA BUILDING DEPARTMENT.
- D. USE E90XX ELECTRODES
- WELDED WIRE FABRIC SHALL BE MADE OF COLD DRAWN WIRE AND SHALL CONFORM TO ASTM A-185 [Fy=65 KSI]. MINIMUM LAP AT SPLICES OF 12 INCHES. PROVIDE MESH IN FLAT SHEETS ONLY. ROLLED MESH IS NOT ACCEPTABLE. OFFSET END-LAPS IN ADJACENT SHEETS TO PREVENT CONTINUOUS LAPS.
- 4. REINFORCING STEEL SHALL HAVE THE FOLLOWING CONCRETE COVER. SEE ACI FOR TOLERANCES:
- A. CONCRETE POURED AGAINST EARTH B. FORMED CONCRETE IN CONTACT WITH EARTH C. CONCRETE EXPOSED TO WEATHER (#6 AND LARGER) D. CONCRETE EXPOSED TO WEATHER (#5 AND SMALLER) 1-1/2" E. SLABS (INCLUDING SLAB SUPPORTING EARTH), WALLS, AND JOISTS NOT EXPOSED TO WEATHER (#11 AND SMALLER) F. OTHER CONCRETE NOT EXPOSED TO WEATHER 1-1/2"
- 5. #5 AND LARGER REINFORCING BARS SHALL NOT BE SPLICED EXCEPT AS LOCATED AND DETAILED ON THE DRAWINGS. #4 AND SMALLER BARS WITH LENGTHS NOT SHOWN SHALL BE CONTINUOUS. PROVIDE CLASS 'B' SPLICE UNLESS NOTED OTHERWISE. ALL BARS IN MASONRY SHALL BE CONTINUOUS, LAPPING 48 BAR DIAMETERS, 2'-0" MINIMUM. HORIZONTAL WALL SPLICES SHALL BE STAGGERED. VERTICAL BARS SHALL NOT BE SPLICED EXCEPT AT HORIZONTAL SUPPORTS, SUCH AS FLOOR OR ROOF, UNLESS DETAILED OTHERWISE. ALL BARS ENDING AT THE FACE OF A WALL, COLUMN, OR BEAM SHALL EXTEND TO WITHIN 2" OF THE FAR FACE AND HAVE A 90 DEGREE HOOK, UNLESS OTHERWISE SHOWN.
- BARS SHALL BE FIRMLY SUPPORTED AND ACCURATELY PLACED AS REQUIRED BY THE ACI STANDARDS, USING TIE AND SUPPORT BARS IN ADDITION TO REINFORCEMENT SHOWN WHERE NECESSARY FOR FIRM AND ACCURATE PLACING. PROVIDE DOWELS TO MATCH ALL REINFORCEMENT AT POUR JOINTS, UNLESS SHOWN OR NOTED OTHERWISE. ALL DOWELS AND BOLTS SHALL BE ACCURATELY SET IN PLACE BEFORE PLACING CONCRETE. NO WELDING OF REINFORCEMENT (INCLUDING TACK WELDING) SHALL BE DONE UNLESS SHOWN ON THE DRAWINGS OR APPROVED BY THE ENGINEER. ALL SLAB AND BEAM REINFORCEMENT SHALL BE CHAIRED UP.
- 7. IN WALL REINFORCING, CURTAINS CONTAINING VERTICAL AND HORIZONTAL BARS OF THE SAME SIZE, VERTICAL BARS SHALL BE PLACED CLOSEST TO THE WALL SURFACE. IN CURTAINS WHICH VERTICAL AND HORIZONTAL BARS ARE OF DIFFERENT SIZES OR SPACING, THE LAYER WITH THE MOST STEEL SHALL BE PLACED CLOSEST TO THE NEAR SURFACE.
- 8. DRAWINGS SHOW TYPICAL REINFORCING CONDITIONS. CONTRACTOR SHALL PREPARE DETAILED PLACEMENT DRAWINGS OF ALL CONDITIONS SHOWING QUANTITY, SPACING, SIZES, CLEARANCES, LAPS, INTERSECTIONS, AND COVERAGE REQUIRED BY THE STRUCTURAL DETAILS, APPLICABLE CODE, AND TRADE STANDARDS. CONTRACTOR SHALL NOTIFY REINFORCING INSPECTOR OF ANY ADJUSTMENTS FROM TYPICAL CONDITIONS WHICH ARE PROPOSED IN PLACEMENT DRAWINGS TO FACILITATE FIELD PLACEMENT OF REINFORCING STEEL AND CONCRETE.
- 9. ALL PRINCIPAL REBAR SHALL TERMINATE WITH A STANDARD HOOK MINIMUM UNLESS SPECIFICALLY DETAILED OTHERWISE. REBAR BENDS SHALL BE MADE COLD. REBAR SHALL NOT BE BENT AFTER ANY PORTION OF THE BAR IS ENCASED IN CONCRETE.
- 10. ALL LAP SPLICES ARE CLASS 'B' LAP SPLICES UNLESS NOTED OTHERWISE.
- 11. ALL WALL FOOTING REINFORCEMENT SHALL BEND AROUND ALL CORNERS AND EXTEND 36 BAR DIAMETERS OR 18 INCHES WHICHEVER IS LARGER. UNLESS NOTED OTHERWISE.
- 12. ALL SLABS ON GRADE LESS THAN 6" IN THICKNESS SHALL BE REINFORCED WITH #4 REBARS AT 16 INCHES ON CENTERS EACH WAY, UNLESS NOTED OTHERWISE. PROVIDE ONE (1) LAYER OF 6X6/W2.9XW2.9 WELDED WIRE FABRIC CONTINUOUS FOR EVERY 3" ARCHITECTURAL CONCRETE FILLS ABOVE THE STRUCTURAL SLAB.
- 13. ALL MECHANICAL, PLUMBING AND ELECTRICAL EQUIPMENT PADS LESS THAN 4" THICK SHALL BE REINFORCED WITH AT LEAST ONE (1) LAYER OF 6X6/W2.9XW2.9 WELDED WIRE FABRIC AND HAVE HOOKED DOWELS (#3 AT 12' ON CENTERS) INTO THE STRUCTURAL SLAB. UNLESS NOTED OTHERWISE. FOR PADS GREATER THAN 4 INCHES THICK, USE REINFORCING AS SHOWN IN THE TYPICAL DETAILS.
- 14. ADDITIONAL REINFORCEMENT SHALL BE PROVIDED AROUND ALL SLAB AND WALL OPENINGS INCLUDING DIAGONAL BARS WITHOUT EXCEPTION.
- 15. ALL STRUCTURAL CONCRETE ELEMENTS REQUIRE REINFORCEMENT SINCE NO PLAIN CONCRETE ELEMENTS ARE USED. ALL CONCRETE SLABS SHALL HAVE A MINIMUM REINFORCEMENT PERCENTAGE OF 0.0018 EACH WAY CONTINUOUS.

GENERAL STRUCTURAL NOTES

WILL BE DONE AT THE CONTRACTOR'S RISK

- 1. THE CONTRACTOR SHALL VERIFY ALL DIMENSIONS & CONDITIONS AT THE JOB SITE PRIOR TO STARTING CONSTRUCTION AND THE ARCHITECT/ENGINEER SHALL BE NOTIFIED OF ANY DISCREPANCIES OR INCONSISTENCIES.
- 2. ALL PHASES OF WORK SHALL CONFORM TO THE MINIMUM STANDARDS OF THE LATEST ADOPTED CODE AND ALL RELEASED ADDENDUM.
- 3. THE CONTRACT CONSTRUCTION DRAWINGS AND SPECIFICATIONS REPRESENT THE FINISHED STRUCTURE, UNLESS OTHERWISE NOTED, THEY DO NOT INDICATE THE METHOD OF CONSTRUCTION. THE CONTRACTOR SHALL PROVIDE ALL MEASURES NECESSARY TO PROTECT THE STRUCTURE, WORKMEN, AND OTHER PERSONS DURING CONSTRUCTION. SUCH MEASURES SHALL INCLUDE, BUT NOT LIMITED TO: BRACING, ALL SHORING, FORMS, AND SCAFFOLDING.
- 4. OPENINGS, POCKETS, ETC. SHALL NOT BE PLACED IN SLABS BEAMS, COLUMNS, WALLS, ETC. UNLESS SPECIFICALLY DETAILED ON THE STRUCTURAL DRAWINGS
- 5. ALL ASTM SPECIFICATIONS NOTED ON THESE DRAWINGS SHALL BE OF THE LATEST REVISION. 6. IN THE EVENT THAT CERTAIN FEATURES OF CONSTRUCTION ARE NOT FULLY SHOWN ON THE DRAWINGS OR CALLED FOR IN THE NOTES OR SPECIFICATIONS. NOTIFY THE ARCHITECT/ENGINEER IMMEDIATELY & WAIT FOR INSTRUCTIONS.
- 7. COST OF ADDITIONAL DESIGN WORK NECESSITATED BY SELECTION OF AN OPTION OR DUE TO ERRORS OR OMISSIONS IN CONSTRUCTION, SHALL BE BORN BY THE CONTRACTOR.
- 8. THE CONTRACTOR ACKNOWLEDGES AND UNDERSTANDS THAT THE CONTRACT DOCUMENTS MAY REPRESENT IMPERFECT DATA AND MAY CONTAIN ERRORS, OMISSIONS, CONFLICTS, INCONSISTENCIES, CODE VIOLATIONS AND IMPROPER USE OF MATERIALS. SUCH DEFICIENCIES WILL BE CORRECTED WHEN IDENTIFIED. THE CONTRACTOR AGREES TO CAREFULLY STUDY AND COMPARE THE INDIVIDUAL CONTRACT DOCUMENTS AND REPORT AT ONCE IN WRITING TO THE OWNER ANY DEFICIENCIES THE CONTRACTOR MAY DISCOVER. THE CONTRACTOR FURTHER AGREES TO REQUIRE EACH SUBCONTRACTOR TO LIKEWISE STUDY THE DOCUMENTS AND TO REPORT AT ONCE ANY DEFICIENCIES DISCOVERED. THE CONTRACTOR SHALL RESOLVE ALL REPORTED DEFICIENCIES WITH CONSULTANT PRIOR TO AWARDING ANY SUBCONTRACTS OR STARTING ANY WORK WITH THE CONTRACTOR'S OWN EMPLOYEES. IF THE CONTRACTOR WITHOUT ADDITIONAL TIME OR ADDITIONAL EXPENSE CANNOT RESOLVE ANY DEFICIENCIES, THE CONTRACTOR SHALL SO INFORM THE OWNER IN WRITING. ANY WORK PERFORMED PRIOR TO RECEIPT OF INSTRUCTIONS FROM THE OWNER
- 9. OPTIONS, IF PROVIDED HEREIN, ARE FOR CONTRACTOR'S CONVENIENCE. HE SHALL BE RESPONSIBLE FOR ALL CHANGES NECESSARY, SHALL COORDINATE ALL DETAILS, AND SHALL OBTAIN ALL REQUIRED APPROVALS.
- 10. ALL WORK SHALL CONFORM TO THE 2022 CALIFORNIA BUILDING CODE (2022 CBC).

DIVISION OF THE STATE ARCHITECT

VENTURA COUNTY COMMUNITY COLLEGE DISTRICT

761 EAST DAILY DRIVE CAMARILLO, CALIFORNIA 93010 TEL: (805) 652-5500

PROJECT TITLE AND SCHOOL LOCATION

24-VCCCD-018- REPLACE **AUTO LIFTS AT WAM**

4667 TELEGRAPH RD. VENTURA, CA

COMMISSIONED ARCHITECT

AMADÒR

amador whittle architects. i 28328 AGOURA RD, 203 | AGOURA HILLS CA, 91301 | 805-530-39



Orion Structural Group, Inc. 223 East Thousand Oaks Boulevard, Suite 304 nousand Oaks, California 91360 - 7734 Phone: 805.390.9242 Fax: 805.494.0418

STAMPS/SEALS





CONCRETE

DESIGN LOADS

EQUIPMENT LOADS

SEISMIC FACTORS:

SITE CLASS D

SDS = 1.594

WIND: 95 MPH

Fa = 1.0

Ss = 1.992 S1 = 0.749

SEISMIC DESIGN CATEGORY D OCCUPANCY CATEGORY II

EXPOSURE C

DESIGN IS BASED ON 2022 CALIFORNIA BUILDING CODE.

MAX. LIFT OF HOIST = 10,000 LBS PER MANUF.

- CONCRETE IS REINFORCED AND CAST-IN-PLACE UNLESS OTHERWISE NOTED. WHERE REINFORCING IS NOT SPECIFICALLY SHOWN OR WHERE DETAILS ARE NOT GIVEN, PROVIDE REINFORCING SIMILAR TO THAT SHOWN FOR SIMILAR CONDITIONS, SUBJECT TO REVIEW BY THE OWNER'S REPRESENTATIVE.
- 2. ALL STRUCTURAL CONCRETE SHALL HAVE A MINIMUM COMPRESSIVE STRENGTH AT 28 DAYS AND A MAX WATER CEMENT RATIO W/C AS FOLLOWS: A. ALL CONCRETE U.N.O.: 3,000 PSI NORMAL WEIGHT, W/C = 0.5
- 3. ALL STRUCTURAL CONCRETE MIXES SHALL DESIGNED BY AN APPROVED LABORATORY AND SHALL BE STAMPED AND SIGNED BY A CIVIL ENGINEER LICENSED IN CALIFORNIA.
- CONCRETE MIXES SHALL BE PREPARED WITH TYPE II/V PORTLAND CEMENT CONFORMING TO ASTM C150. CONCRETE MIX DESIGNS CONTAINING FLY ASH MAY BE USED WHERE CONCRETE IS NOT VISUALLY EXPOSED. FLY ASH SHALL CONFORM WITH ASTM C618 AND MAY REPLACE UP TO 20% PORTLAND CEMENT BY VOLUME.
- NORMAL WEIGHT CONCRETE AGGREGATES SHALL CONFORM TO ASTM C33. LIGHT WEIGHT CONCRETE AGGREGATES SHALL CONFORM TO ASTM C330.
- 6. NO MORE THAN ONE GRADE OF CONCRETE SHALL BE ON THE JOB SITE AT ANY ONE TIME.
- 7. THOROUGHLY CLEAN AND ROUGHEN ALL HARDENED CONCRETE AND MASONRY SURFACES TO RECEIVE NEW CONCRETE. INTERFACE SHALL BE ROUGHENED TO A FULL AMPLITUDE OF 1/4" UNLESS NOTED OTHERWISE.
- 8. KEY AND DOWEL POUR JOINTS AS SHOWN ON THE PLANS. ANY DEVIATION FROM POUR JOINTS SHOWN ON THE PLANS MUST BE APPROVED BY THE OWNER'S REPRESENTATIVE.
- 9. NON-SHRINK CEMENT GROUT SHALL HAVE A MINIMUM 28 DAY COMPRESSIVE STRENGTH OF 7000 PSI. USE "QUIKRETE" (LARR #25451) OR "RAPID SET" (LARR #24654).
- 10. DEFECTIVE CONCRETE (VOIDS, ROCK POCKETS, HONEYCOMBS, CRACKING, ETC.) SHALL BE REMOVED AND REPLACED AS DIRECTED BY THE OWNER'S REPRESENTATIVE.


GENERAL NOTES TYPICAL DETAILS


SHEET TITLE:

DJECT NO.:24-VCCCD-018 PROJECT ARCH: WJA ^{'N:} MG

SHEET NUMBER:

JOINTS AT SLAB ON GRADE TYP. CONC. REINF. DEVEL. LENGTH / LAP SPLICE SCHED. SCALE: 1" = 1'-0" 6 SCALE: 1" = 1'-0"

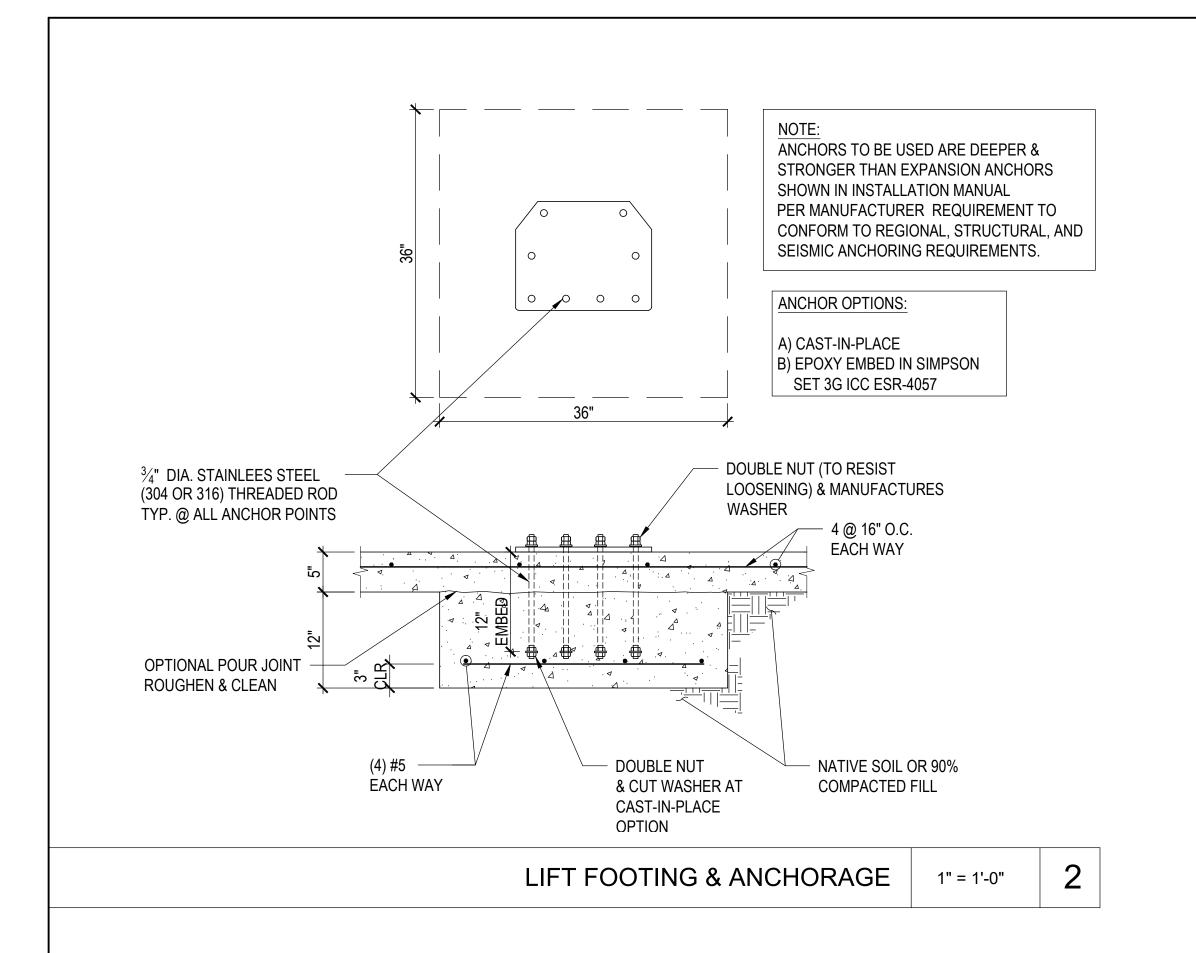

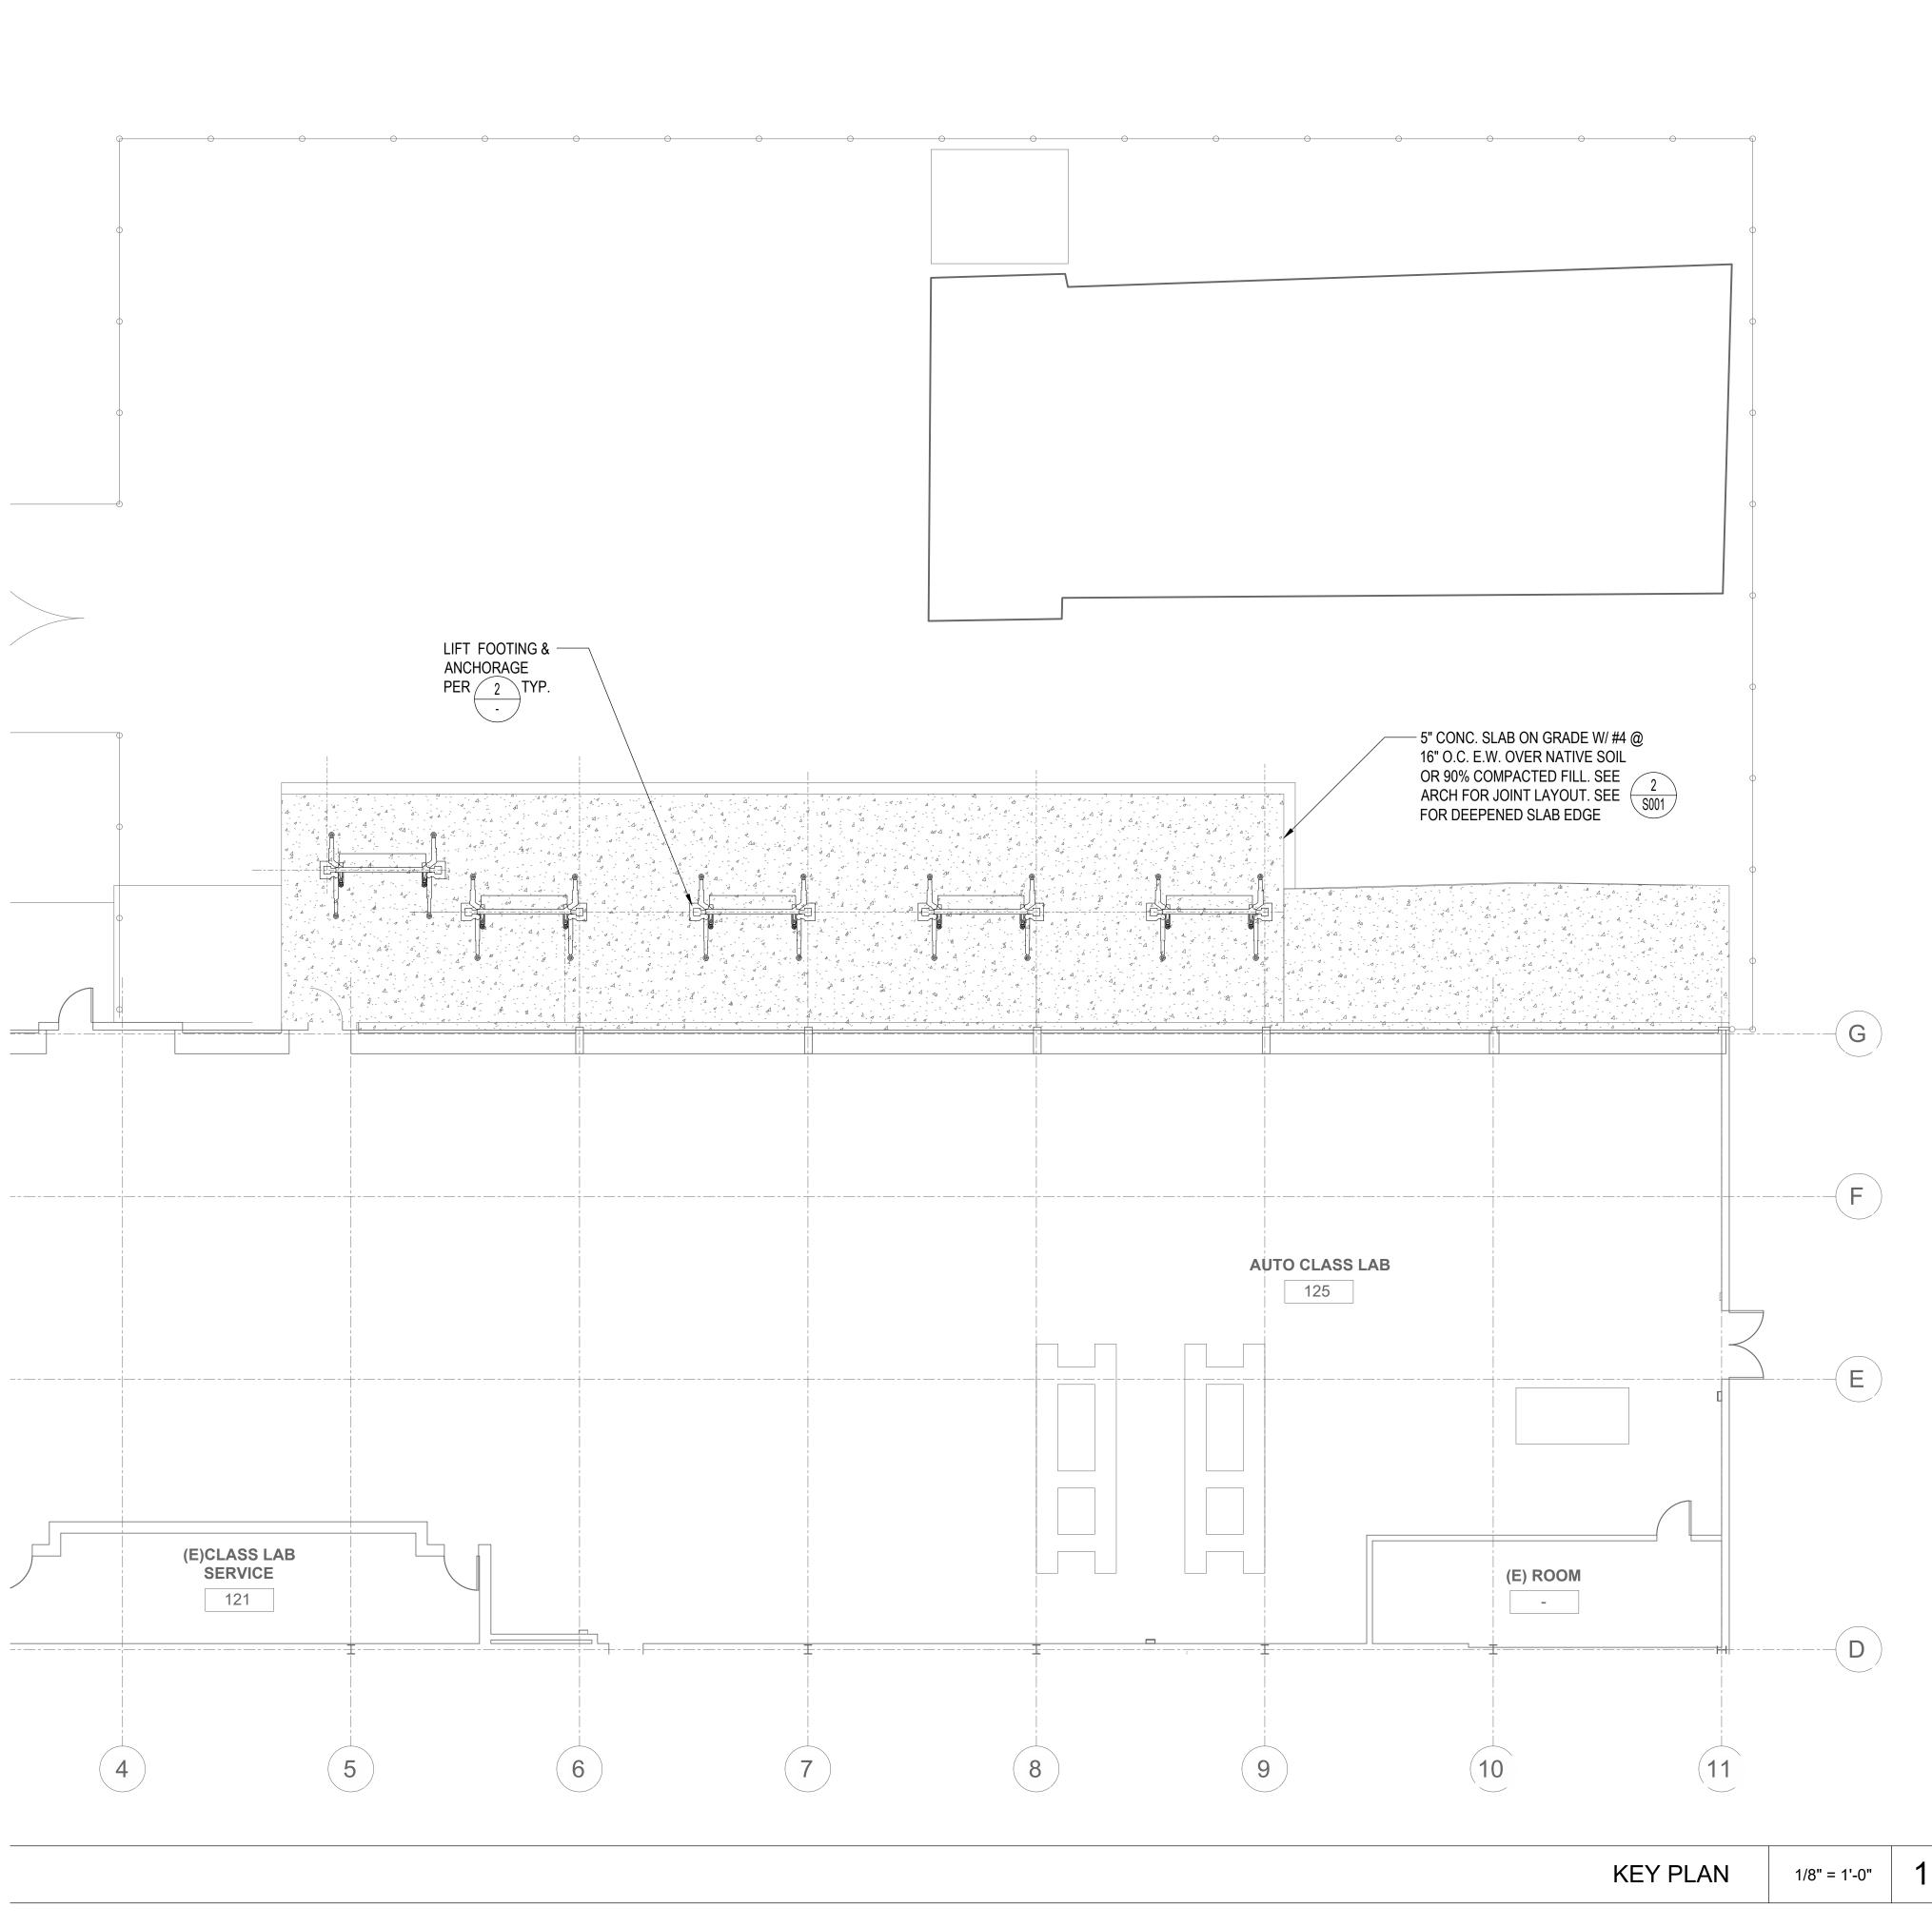



DIVISION OF THE STATE ARCHITECT



VENTURA COUNTY COMMUNITY
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AMADOR

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Orion Structural

Orion Structural Group, Inc. 223 East Thousand Oaks Boulevard, Suite 304 Thousand Oaks, California 91360 - 7734 Phone: 805.390.9242 Fax: 805.494.0418 O.S.G. #24604

STAMPS/SEALS



08/22/2024

ORGE

C-20348

ANUARY 31, 2025

KEY PLAN & STRUCTURAL DETAILS

PROJECT NO.: 24-VCCCD-018 PROJECT ARCH: WJA

S103

08/22/2024 SHEE

GENERAL NOTES

RESISTANCE RATING. 12. ALL ELECTRICAL WORK SHALL BE PER THE APPLICABLE CEC

CODE. CONTRACTOR SHALL INCLUDE IN HIS BID ALL REQUIRED LABOR, MATERIAL, EXPERTISE AND QUALIFIED PERSONNEL TO COMPLETELY INSTALL IN A CODE COMPLIANT MANNER, ALL WORK SHOWN ON THE PLANS.

13. WHEN THERE ARE DISCREPANCIES BETWEEN CONTRACT DOCUMENTS (DRAWINGS), OBTAIN CLARIFICATION FROM THE ENGINEER PRIOR TO BID. FOR BIDDING PURPOSES THE MORE STRINGENT OR MORE EXPENSIVE REQUIREMENT(S) SHALL APPLY.

14. DURING CONSTRUCTION, THE CONTRACTOR SHALL MAINTAIN A DAILY RECORD OF ALL DEVIATIONS FROM THE BID DRAWINGS. ALL DIMENSIONS AND OTHER INFORMATION NECESSARY TO COMPLETELY EXPLAIN AND LOCATE ALL ELEMENTS OF THESE DEVIATIONS SHALL BE RECORDED. UPON COMPLETION OF WORK, THE CONTRACTOR SHALL SUBMIT TO THE OWNER, ONE COMPLETE SET OF REPRODUCIBLE DRAWINGS CORRECTED TO REFLECT "AS-BUILT" CONDITIONS OF THE WORK.

15. "PROVIDE" SHALL BE DEFINED AS: FURNISH AND INSTALL.

16. ALL MATERIALS, EQUIPMENT, CONDUIT AND WIRING SHALL BE NEW AND PROVIDED BY THE CONTRACTOR. REFER TO THE PLANS FOR ADDITIONAL REQUIREMENTS FOR EQUIPMENT AND MATERIAL APPROVED FOR USE UNDER THIS CONTRACT

17. PROVIDE ELECTRICAL PANELS WITH TYPEWRITTEN "AS-BUILT" PANEL SCHEDULE. PANEL SCHEDULE SHALL INCLUDE LOCATION, QUANTITY AND TYPE OF DEVICES SERVED. PANEL SCHEDULE SHALL BE REVISED AS REQUIRED TO REFLECT REMOVED OR DEMOLISHED CIRCUITS.

THE SEISMIC ANCHORAGE OF ELECTRICAL EQUIPMENT SHALL CONFORM TO ASCE 7-10.

19. CONTRACTOR SHALL SUBMIT A CALCULATIONS AND DETAILS FOR APPROVAL WHEN USING AN INSTALLATION METHOD NOT COVERED UNDER ANY OF THE STRUCTURAL DRAWINGS STANDARD DETAILS.

REVISED: 02/14/2020

A.F.F.

BKR.

CKT.

C.O.

CU

(E)

(ER)

F.O.

GFI.G.F.I

J.BOX

M.H.

N.I.C.

PH OR Ø

PΑ

REV.

RSP

SW

XFMR

TVSS

UFER

U.O.N.

WM

WP

W.P.

V.L.

TYP.

UG

A OR AMP

20. ALL MATERIALS, EQUIPMENT, CONDUIT AND WIRING SHALL BE NEW AND PROVIDED BY THE CONTRACTOR. REFER TO THE SPECIFICATIONS FOR ADDITIONAL REQUIREMENTS FOR EQUIPMENT AND MATERIAL APPROVED FOR USE UNDER THIS CONTRACT

USING APPROVED METHODS TO MAINTAIN THE FIRE 21. WIRING FOR ALL LOW VOLTAGE SYSTEMS SHALL BE **ENCLOSED IN CONDUIT AND/OR RACEWAY**

> 22. ALL RACEWAYS INSIDE OF BUILDING SHALL BE CONCEALED. INCLUDE ALL REQUIRED DEMOLITION, CUTTING, PATCHING AND FINISH TO MATCH EXISTING INSTALLATION AS REQUIRED TO INSTALL NEW CONDUIT AND RACEWAYS IN EXISTING BUILDING.

23. PROVIDE ELECTRICAL PANELS WITH ENGRAVED NAMEPLATE ON OUTSIDE OF PANEL ABOVE DOOR OPENING.

24. SUPPORT CONDUIT 2-1/2 INCH TRADE SIZE OR SMALLER WITH U.L. LISTED CLAMPS AND HANGERS IN ACCORDANCE WITH SMACNA STANDARDS

25. EQUIPMENT SPECIFIED ON THESE DRAWING ARE BASIS OF

26. CONTRACTOR SHALL ASSUME FULL RESPONSIBILITY FOR ALL ADDITIONAL DESIGN AND CONSTRUCTION COSTS INCURRED BY THE USE OF ANY PRODUCT OTHER THAN THE BASIS OF DESIGN.

27. PROVIDE BREAKERS TIES TO BREAKERS FEEDING MULTI WIRE RUNS.

28. THESE PLANS ARE DIAGRAMMATIC, CONDUIT EXACT ROUTING, BOXES, FASTENERS, ETC. ARE CONSIDERED AS PART OF THE MEANS AND METHODS THAT THE CONTRACTOR IS USING TO PROVIDE AN OPERABLE AND APPROVED INSTALLATION.

29. 110.2 APPROVAL: ALL ELECTRICAL EQUIPMENT SHALL BE LABELED, LISTED OR CERTIFIED BY A NATIONALLY RECOGNIZED TESTING LABORATORY ACCREDITED BY THE UNITED STATES OCCUPATIONAL SAFETY HEALTH ADMINISTRATION.

30. 130.5(c) VOLTAGE DROP: THE MAXIMUM COMBINED VOLTAGE DROP ON BOTH INSTALLED FEEDER CONDUCTORS AND BRANCH CIRCUIT CONDUCTORS TO THE FARTHEST CONNECTED LOAD OR OUTLET SHALL NOT EXCEED 5 PERCENT.

FOR ELECTRICAL NO MORE THAN 360 DEGREE TURNS(4-90s) ARE ALLOWED BETWEEN PULLBOXES, J-BOXES, CONDUIT BODIES AND FOR LOW VOLTAGE/DATA/TELECOMM NO MORE THAN 180 DEGREE TURNS(2-90s) ARE ALLOWED BETWEEN PULLBOXES, J-BOXES, CONDUIT BODIES. CONTRACTOR TO PROVIDE REQUIRED PULLBOXES, J-BOXES TO SATISFY THESE REQUIREMENTS.

STANDARD ABBREVIATIONS

ABOVE FINISHED FLOOR

ASPHALT CONCRETE

EXISTING, RELOCATED

GROUND FAULT INTERRUPTER

LOCAL DISTRIBUTION FRAME

MAIN DISTRIBUTION FRAME

MOUNTING HEIGHT

NOT IN CONTRACT

PUBLIC ADDRESS

REMOVE AND RELOCATE

REMOTE SECURITY PANEL

UNLESS OTHERWISE NOTED

SIGNALING LINE CIRCUIT

PHASE

REMOVED

REVISED

SWITCH

TYPICAL

TRANSFORMER

UFER GROUND

UNDERGROUND

WEATHERPROOF

WEATHERPROOF

VERIFY LOCATION.

WIREMOLD

INTERMEDIATE DISTRIBUTION FRAME

(COMPUTER/NETWORKING SYSTEM)

(COMPUTER/NETWORKING SYSTEM)

(COMPUTER/NETWORKING SYSTEM)

TRANSIENT VOLTAGE SURGE SUPPRESSER

AMPERES

BREAKER

CONDUIT

CIRCUIT

COPPER

EXISTING

FIBER OPTIC

JUNCTION BOX

BARE COPPER

CONDUIT ONLY

DIVISION OF THE STATE ARCHITECT

VENTURA COUNTY COMMUNITY COLLEGE DISTRICT

> 761 EAST DAILY DRIVE CAMARILLO, CALIFORNIA 93010 TEL: (805) 652-5500

PROJECT TITLE AND SCHOOL LOCATION

24-VCCCD-018- REPLACE **AUTO LIFTS AT WAM**

4667 TELEGRAPH RD. VENTURA, CA

COMMISSIONED ARCHITECT

amador whittle architects, in 28328 AGOURA RD, 203 | AGOURA HILLS CA, 91301 | 805-530-393 CONSULTANT



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STAMPS/SEALS



C-20348

SHEET TITLE:

ELECTRICAL FRONT SHFFT

PROJECT NO.: 24-VCCCD-018 PROJECT ARCH: WJA

8/15/2024

SHEET NUMBER:

PART 2 - PRODUCTS

1. SCOPE

- 1.1. PROVIDING LIGHT POLES INCLUDING LIGHT FIXTURES AND BRANCH CIRCUIT FOR SOCCER FIELD.
- 1.2. PROVIDING EGRESS LIGHTING IN SOCCER FIELD AND AT BLEACHERS PATH OF

2. GENERAL REQUIREMENTS

- 2.1. PROVIDE ALL EQUIPMENT, MATERIAL, LABOR. SERVICE, SUPPORT AND SKILLED SUPERVISION FOR ALL WORK SHOWN ON THE ELECTRICAL DRAWINGS AND AS SPECIFIED.
- 2.2. THE ENTIRE WORK PROVIDED SHALL BE CONSTRUCTED AND FINISHED IN EVERY RESPECT IN A WORKMANLIKE AND SUBSTANTIAL MANNER. FURNISH AND INSTALL ALL WORK AS MAY BE NECESSARY TO COMPLETE THE SYSTEMS IN ACCORDANCE WITH THE BEST TRADE PRACTICE AND TO THE SATISFACTION OF THE OWNER. THE ENTIRE INSTALLATION SHALL BE READY IN EVERY RESPECT FOR SATISFACTORY AND EFFICIENT OPERATION WHEN COMPLETE.
- 2.3. THE DRAWINGS SHOW VARIOUS CONDUIT AND WIRING SYSTEMS SCHEMATICALLY AND EXISTING CIRCUIT NUMBERS ARE FOR REFERENCE ONLY BALANCE EXISTING PANELBOARD AND RECORD ALL NEW CIRCUIT NUMBERS ON AS-BUILT DRAWINGS.
- 2.4. SUBMIT A SINGLE GUARANTEE STATING THAT ALL PORTIONS OF THE WORK ARE IN ACCORDANCE WITH CONTRACT REQUIREMENTS. GUARANTEE ALL WORK AGAINST FAULTY AND IMPROPER MATERIAL AND WORKMANSHIP FOR A PERIOD OF ONE YEAR FROM DATE OF FINAL ACCEPTANCE BY THE OWNER EXCEPT THAT WHERE GUARANTEES OR WARRANTIES FOR LONGER TERMS ARE SPECIFIED BY CONTRACT, SUCH LONGER TERM SHALL APPLY. AT NO ADDITIONAL COST TO THE OWNER, WITHIN 24HOURS AFTER NOTIFICATION, CORRECT ANY DEFICIENCIES WHICH OCCUR DURING THE GUARANTEE PERIOD.
- ALL TO THE SATISFACTION OF THE OWNER. 2.5. PROVIDE ALL MATERIAL AND EQUIPMENT AND MAKE THE FINAL CONNECTIONS
- 2.6. FURNISH A WRITTEN GUARANTEE FOR A PERIOD OF ONE-YEAR FROM DATE OF

ACCEPTANCE.

TO ALL EQUIPMENT.

- 2.7. ALL CORE CUTTING , DRILLING AND PATCHING: 2.7.1. THE CONTRACTOR SHALL DO ALL DRILLING, CUTTING, AND PATCHING OF GENERAL CONSTRUCTION WORK EXISTING OR NEW, ROUGH FINISH AND TRIM WHICH MAY BE REQUIRED FOR THE INSTALLATION OF ALL OF HIS WORK. ALL PATCHING SHALL BE OF THE SAME MATERIALS, WORKMANSHIP AND FINISH AS THE ORIGINAL WORK, AND SHALL ACCURATELY MATCH ALL SURROUNDING WORK.
- 2.7.2. NO HOLES WILL BE ALLOWED IN ANY STRUCTURAL MEMBERS WITHOUT THE WRITTEN APPROVAL OF THE PROJECT'S STRUCTURAL ENGINEER.
- 2.7.3. THE CONTRACTOR SHALL BE RESPONSIBLE FOR PATCHING AND REPAIRING SURFACES WHERE HE IS REQUIRED TO PENETRATE FOR WORK UNDER THIS CONTRACT.
- 2.7.4. PENETRATIONS SHALL BE SEALED TO MEET THE RATED INTEGRITY OF THE SERVICE REQUIRED TO BE PATCHED AND REPAIRED. SURFACE SHALL BE PAINTED OR FINISHED TO MATCH THE EXISTING SURFACE.

CODES AND PERMITS

- 3.1. ALL WORK SHALL BE DONE IN FULL COMPLIANCE WITH THE CALIFORNIA ELECTRICAL CODE AND ALL LOCAL CODES OR ORDINANCES HAVING
- 3.2. ALL EQUIPMENT AND MATERIALS SHALL BE NEW EXCEPT WHERE SPECIFICALLY NOTED TO BE REUSED AND LISTED BY THE UNDERWRITER'S LABORATORIES INC., MANUFACTURED IN ACCORDANCE WITH ASME, NEMA, ANSI OR IEEE STANDARDS, AND APPROVED BY ALL AUTHORITIES HAVING JURISDICTION.
- SECURE AND PAY FOR ALL NECESSARY APPROVALS, PERMITS, INSPECTIONS ETC., AND DELIVER THE OFFICIAL RECORDS OF THE GRANTING OF PERMITS TO THE OWNER WITHOUT ADDITIONAL COST TO THE OWNER.

4. COORDINATION

- 4.1. COORDINATE THE WORK OF THIS SECTION WITH THE WORK OF OTHER SECTIONS IN AMPLE TIME FOR THE PROPER INSTALLATION AND CONNECTION AND FOR THE PROVISION OF ALL OPENINGS REQUIRED IN FLOORS AND WALLS.
- 4.2. CAREFULLY CHECK SPACE REQUIREMENTS WITH OTHER TRADES TO INSURE THAT ALL EQUIPMENT AND MATERIALS CAN BE INSTALLED IN THE SPACES ALLOTTED THERETO. INSTALL ALL WORK TO AVOID OBSTRUCTIONS AND TO PRESERVE HEADROOM AND CEILING HEIGHT REQUIREMENTS.
- 4.3. CAREFULLY CHECK THE DOCUMENTS WITH OTHER TRADES TO ASCERTAIN THE REQUIREMENTS OF ANY MATERIALS OR EQUIPMENT BEING FURNISHED AND/OR INSTALLED BY THAT SECTION AND PROVIDE THE PROPER INSTALLATION AND/OR CONNECTIONS INCLUDING ANY CONTROL WIRING REQUIRED.

CLEANING PREMISES

5.1. THE CONTRACTOR SHALL KEEP ALL PARTS OF THE BUILDING AND SITE FREE FROM ANY ACCUMULATIONS OF RUBBISH OR WASTE MATERIALS CAUSED BY HIS WORKMEN. AND SHALL REMOVE SUCH ACCUMULATIONS FROM THE BUILDING. SITE AND PROPERTY. JOB SITE SHALL BE CLEANED AT THE END OF EACH WORKING DAY.

6. RECORD DRAWINGS

6.1. KEEP UP TO DATE. A COMPLETE SET OF DRAWINGS WITH RED MARK TO INDICATE ANY CHANGES FROM THE ORIGINAL DRAWINGS. UPON COMPLETION OF THE INSTALLATION, FURNISH A COMPLETE SET OF MARKED UP DRAWINGS AS "RECORD DRAWINGS". THESE DRAWINGS SHALL BE SUBMITTED TO THE OWNER FOR APPROVAL. AFTER APPROVAL THEY SHALL BECOME THE PROPERTY OF THE OWNER. FINAL PAYMENT WILL BE WITHHELD UNTIL RECEIPT OF THE APPROVED DRAWINGS.

7. PROTECTION & SAFEGUARDS

7.1. THE CONTRACTOR SHALL ERECT AND MAINTAIN SUITABLE BARRIERS PROTECTIVE DEVICES, LIGHTS AND WARNING SIGNS WHERE REQUIRED FOR THE PROTECTION OF THE PUBLIC AND EMPLOYEES ABOUT THE BUILDING. HE SHALL BE FULLY RESPONSIBLE FOR ANY LOSS OR INJURY TO PERSONS OR PROPERTY RESULTING FROM HIS NEGLECT OF THESE PRECAUTIONS, HIS OWN CARELESSNESS, OR THE CARELESSNESS OR NEGLECT OF HIS EMPLOYEES, OR HIS SUB-CONTRACTOR AND/OR THEIR EMPLOYEES.

8. SHOP DRAWINGS/SUBMITTALS

8.1. WITHIN THIRTY (30) DAYS AFTER AWARD OF THE GENERAL CONTRACT. THE CONTRACTOR SHALL SUBMIT DIGITAL PDF OF ALL REQUIRED SHOP DRAWINGS AND BROCHURES. SHOP DRAWINGS AND BROCHURES WILL BE REQUIRED FOR THE FOLLOWING EQUIPMENT; CIRCUIT BREAKERS, LIGHT FIXTURES, LIGHT POLES, LIGHTING CONTROL PANEL, CONDUIT INCLUDING SUPPORTS, ACCESSORIES AND FITTINGS, WIRES AND CONNECTORS. CONTRACTOR SHALL SUBMIT ITEMS TO BE USED IN THIS PROJECT FOR REVIEW AND APPROVAL EQUIPMENT INSTALLED WITHOUT APPROVAL THEREOF SHALL BE DONE AT THE RISK OF THE CONTRACTOR AND THE COST FOR REMOVAL OF SUCH EQUIPMENT OR RELATED WORK WHICH IS JUDGED UNSATISFACTORY FOR ANY REASON SHALL BE AT THE EXPENSE OF THIS CONTRACTOR.

9. EXISTING CONDITIONS

- 9.1. BEFORE SUBMITTING BID, BECOME THOROUGHLY FAMILIAR WITH ACTUAL EXISTING CONDITIONS ON SITE AND OF THE PRESENT INSTALLATIONS TO WHICH CONNECTIONS MUST BE MADE OR WHICH MUST BE CHANGED OR ALTERED. THE INTENT OF THE WORK IS SHOWN ON THE DRAWINGS AND DESCRIBED HEREINAFTER AND NO CONSIDERATION WILL BE GRANTED BY REASON OF LACK OF FAMILIARITY ON THE PART OF THE CONTRACTOR WITH ACTUAL PHYSICAL CONDITIONS AT THE SITE.
- 9.2. WHERE SPECIFICALLY CALLED FOR ON THE DRAWING OR WHEN PERMISSION IS SPECIFICALLY GIVEN BY THE OWNER, EXISTING EQUIPMENT AND MATERIAL MAY BE REUSED. SALVAGEABLE MATERIAL, UNLESS OTHERWISE INSTRUCTED BY THE OWNER, SHALL BECOME THE PROPERTY OF THE CONTRACTOR AND BE REMOVED FROM THE SITE.

1. MATERIALS

1.1. MATERIALS AND EQUIPMENT : ALL ELECTRICAL MATERIALS AND EQUIPMENT SHALL BE NEW AND SHALL BE LISTED BY UNDERWRITER'S LABORATORY (UL) AND BEAR THEIR LABEL LISTED AND CERTIFIED BY A NATIONALLY RECOGNIZED TESTING LAB (NRTL) THAT IS ALSO RECOGNIZED BY THE LOCAL AUTHORITY HAVING JURISDICTION (AHJ)

GROUNDING SYSTEM

- 2.1. ALL ELECTRICAL EQUIPMENT AND SYSTEMS SHALL BE GROUNDED IN ACCORDANCE WITH CALIFORNIA ELECTRICAL CODE AND TITLE 24, CALIFORNIA ADMINISTRATIVE CODE, PART 3.
- 2.2. GROUNDING SHALL BE AS INDICATED ON THE DRAWINGS AND BONDED TO THE
- COLD WATER PIPING SYSTEM. 2.3. PROVIDE A GROUNDING CONDUCTOR, WHICH SHALL BE IN ADDITION TO THE CIRCUIT CONDUCTORS INDICATED, IN EACH NONMETALLIC CONDUIT USED FOR
- LIGHTING AND POWER CIRCUITS. 2.4. ALL SYSTEM GROUNDING CONDUCTORS SHALL BE COPPER. ALL GROUND CONNECTIONS SHALL BE ACCESSIBLE AND MADE WITH COPPER ALLOY FITTINGS.

3. PANELBOARDS

3.1. ALL EXISTING PANELBOARDS ARE TO REMAIN. CONTRACTOR IS REQUIRED TO PROVIDE AN UPDATED TYPEWRITTEN PANEL DIRECTORY TO REFLECT THE CHANGES MADE ON PANEL LOADS.

4. WIRING DEVICES

- 4.1. THE CATALOG NUMBERS OF ALL WIRING DEVICES. UNLESS OTHERWISE SPECIFIED ARE THOSE OF THE HUBBELL COMPANY. OR AS NOTED TO ESTABLISH THE QUALITY DESIRED. EQUAL EQUIPMENT BY GENERAL ELECTRIC. BRYANT, SIERRA, SLATER, LEVITON OR A&H WILL BE ACCEPTABLE
- 4.2. FURNISH AND INSTALL WALL SWITCHES AT EACH LOCATION INDICATED ON THE DRAWINGS. WHERE MORE THAN ONE SWITCH OCCURS AT THE SAME LOCATION, THEY SHALL BE INSTALLED UNDER A MULTIPLE GANG PLATE SWITCH HANDLE SHALL BE WHITE COLOR. SWITCHES HANDLES SHALL BE WHITE COLOR. SWITCHES SHALL BE A.C. QUIET TYPE RATED 20 AMPERES AT 120 AND/OR 277 VOLTS. - n-LIGHT CONTROLS OR EQUIVALENT.
- 4.3. FURNISH AND INSTALL CONVENIENCE RECEPTACLE AT EACH LOCATION INDICATED ON THE DRAWINGS. RECEPTACLE SHALL BE HUBBELL, LEVITON OR **EQUIVALENT**
- 4.4. PLATES FOR WIRING DEVICES SHALL BE WHITE OR AS SELECTED BY OWNER REPRESENTATIVE.

5. OUTLET BOXES

5.1. JUNCTION BOXES SHALL BE 4 BY 4 BY 2-1/8 INCHES DEEP WITH COVERS UNLESS OTHERWISE NOTED OR REQUIRED BY CODE. JUNCTION BOXES ABOVE SUSPENDED CEILINGS FOR LIGHTING AND FOR DATA/COMMUNICATION SYSTEMS SHALL BE 4-11/16 BY 2-1/8 INCHES DEEP MINIMUM, TO BE INSTALLED ADJACENT TO RECESSED FIXTURE IN SUCH MANNER AS TO BE ACCESSIBLE THROUGH THE OPENING IN THE CEILING IN WHICH THE FIXTURE IS INSTALLED.

6. LIGHTING FIXTURES

- 6.1. FURNISH AND INSTALL UNDERWRITERS LABORATORIES, INC. LISTED LIGHTING FIXTURES AS INDICATED ON DRAWINGS
- 6.2. ALL FIXTURES SHALL BE FURNISHED COMPLETE WITH LED LAMPS.
- 6.3. THIS CONTRACTOR SHALL FURNISH AND INSTALL ALL SUPPORTS FOR ALL LIGHTING FIXTURES INCLUDING LIGHT POLES.

7. CONDUIT. EMT AND FITTINGS 7.1. RACEWAYS LARGER THAN 3-INCH SHALL BE GALVANIZED RIGID STEEL UNLESS

- OTHERWISE SPECIFIED. 7.2. RIGID METAL RACEWAYS SHALL BE INSTALLED IN WET LOCATIONS. IN OR
- UNDER CONCRETE SLABS ON GRADE WITH OR WITHOUT VAPOR BARRIER. IN CONCRETE WALLS AND COLUMNS, IN CONCRETE SLABS, WALLS AND COLUMNS EXPOSED TO THE WEATHER WITH OR WITHOUT VAPOR BARRIERS: WHERE EXPOSED IN AREAS OPEN TO THE WEATHER, WHERE EXPOSED ON WALLS AND COLUMNS UP 6 FEET ABOVE THE FLOOR, EXCEPT IN ELECTRICAL OR TELEPHONE RISER CLOSETS; AND IN MECHANICAL ROOMS IN SIZES LARGER THAN 1-IN UP TO 7-FEET 0 INCHES ABOVE FINISHED FLOOR.
- 7.3. ELECTRICAL METALLIC TUBING IN SIZES UP TO 3-INCH MAY BE INSTALLED IN INTERIOR SPACES WHERE RIGID RACEWAY IS NOT REQUIRED. AND WHERE PERMITTED BY THE LOCAL CODE AUTHORITIES HAVING JURISDICTION.
- 7.4. JOIN ELECTRICAL METALLIC TUBING WITH WATERTIGHT STEEL COMPRESSION TYPE THREADLESS FITTINGS THROUGHOUT. USE CONNECTORS OF FACTORY PRE INSULATED TYPE IN ALL SIZES. EMT FITTINGS USING SET SCREWS ARE NOT ACCEPTABLE. EMT CONNECTIONS SHALL BE OF MALLEABLE IRON OR STEEL.
- 7.5. FLEXIBLE RACEWAY SHALL BE STEEL AND SHALL BE USED FOR REMOVABLE LIGHTING FIXTURES IN FURRED CEILING SPACES AND AT LOCATIONS AS SHOWN, USE FACTORY PRE INSULATED FITTINGS OF THE TYPE APPROVED AS GROUNDING CONNECTORS. PROVIDE GROUNDING WIRE IN ALL NON-LIQUID TIGHT FLEXIBLE RACEWAY SIZED ACCORDING TO CODE. MAXIMUM LENGTH OF FLEXIBLE RACEWAYS SHALL BE 6-FEET.
- 7.6. NON METALLIC CONDUIT SHALL BE POLYVINYL CHLORIDE (PVC) RIGID CONDUIT SCH.40, TYPE II FOR UNDERGROUND INSTALLATION ONLY WITH SOLVENT WELDED JOINTS, CONFORMING TO UL REQUIREMENTS, LISTED FOR EXPOSED AND DIRECT BURIAL APPLICATION.

8. CONDUCTORS

- 8.1. ALL CONDUCTORS SHALL BE COPPER WITH THHN 90 DEGREE C INSULATION.
- 8.2. WIRE AND CABLE SHALL BE NEW, MANUFACTURED NOT MORE THAN 6 MONTHS PRIOR TO INSTALLATION, SHALL HAVE SIZE, TYPE OF INSULATION, VOLTAGE RATING AND MANUFACTURER'S NAME PERMANENTLY MARKED ON OUTER COVERING AT REGULAR INTERVALS.
- 8.3. CONDUCTORS SHALL BE CONTINUOUS FROM OVER-CURRENT PROTECTIVE DEVICE TO TERMINAL OR FARTHEST OUTLET. NO JOINTS SHALL BE MADE EXCEPT IN PULL, JUNCTION OR OUTLET BOXES.
- 8.4. JOINTS IN WIRES SMALLER THAN NO.6 SHALL BE MADE WITH IDEAL SUPER WIRE NUTS OR SCOTCH TYPE "R". "Y" OR "B" SPRING CONNECTORS. JOINTS IN WIRES NO. 6 AND LARGER SHALL BE MADE WITH APPROVED SOLDERLESS CONNECTORS. ALL JOINTS IN CABLES NO.6 AND LARGER SHALL BE INSULATED AND TAPED.

8.5. NEUTRAL CONDUCTORS SHALL NOT BE BROKEN AT ANY DUPLEX RECEPTACLE, LIGHTING FIXTURE OR SIMILAR WIRING DEVICE IN MULTI-WIRE (3 WIRE OR 4 WIRE) CIRCUITS. GROUNDED NEUTRAL SHALL NOT DEPEND ON DEVICE CONNECTIONS FOR CONTINUITY. NEUTRAL WIRES CAN BE SPLICED TOGETHER WITH PIGTAIL TO NEUTRAL TERMINAL ON RECEPTACLE, LIGHTING FIXTURE OR SIMILAR DEVICE. IF DEVICE OR FIXTURE IS REMOVED, NEUTRAL WILL REMAIN

8.6. PROVIDE AN INDIVIDUAL NEUTRAL CONDUCTOR FOR EACH BRANCH CIRCUIT. H

EQUIPMENT CONNECTIONS

CONTINUOUS.

9.1. MAKE CONNECTIONS TO ALL MOTORS, MOTOR CONTROLLERS AND ELECTRICALLY OPERATED EQUIPMENT WHETHER FURNISHED AS A PART OF THIS CONTRACT OR FURNISHED BY THE OWNER FOR INSTALLATION UNDER THIS CONTRACT. FURNISH AND INSTALL ALL CONDUITS AND CONDUCTORS REQUIRED FOR THESE CONNECTIONS AND FOR CONTROL WIRING AS INDICATED BY ELECTRICAL IN OTHER SECTIONS.

10. DISCONNECT SWITCHES AND CONTROL WIRING

10.1. FURNISH AND INSTALL HORSE POWER RATED DISCONNECT SWITCHES FOR ALL MOTORS, CONTROL CIRCUITS AND OTHER ELECTRICAL EQUIPMENT AS REQUIRED BY CODE WHETHER OR NOT SHOWN ON THE DRAWINGS. A DISCONNECT SWITCH SHALL BE LOCATED WITHIN SIGHT FROM THE CONTROLLER DISCONNECT LOCATION. WHERE A MOTOR IS NOT WITHIN SIGHT FROM THE CONTROLLER DISCONNECT LOCATION, AN ADDITIONAL DISCONNECTING SWITCH SHALL BE PROVIDED WITHIN SIGHT OF THE MOTOR LOCATION.

DIVISION OF THE STATE ARCHITECT



VENTURA COUNTY COMMUNITY COLLEGE DISTRICT

761 EAST DAILY DRIVE CAMARILLO, CALIFORNIA 93010 TEL: (805) 652-5500

PROJECT TITLE AND SCHOOL LOCATION

24-VCCCD-018- REPLACE **AUTO LIFTS AT WAM**

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STAMPS/SEALS






SHEET TITLE:

ELECTRICAL SPECIFICATIONS

PROJECT NO.:24-VCCCD-018 PROJECT ARCH: WJA

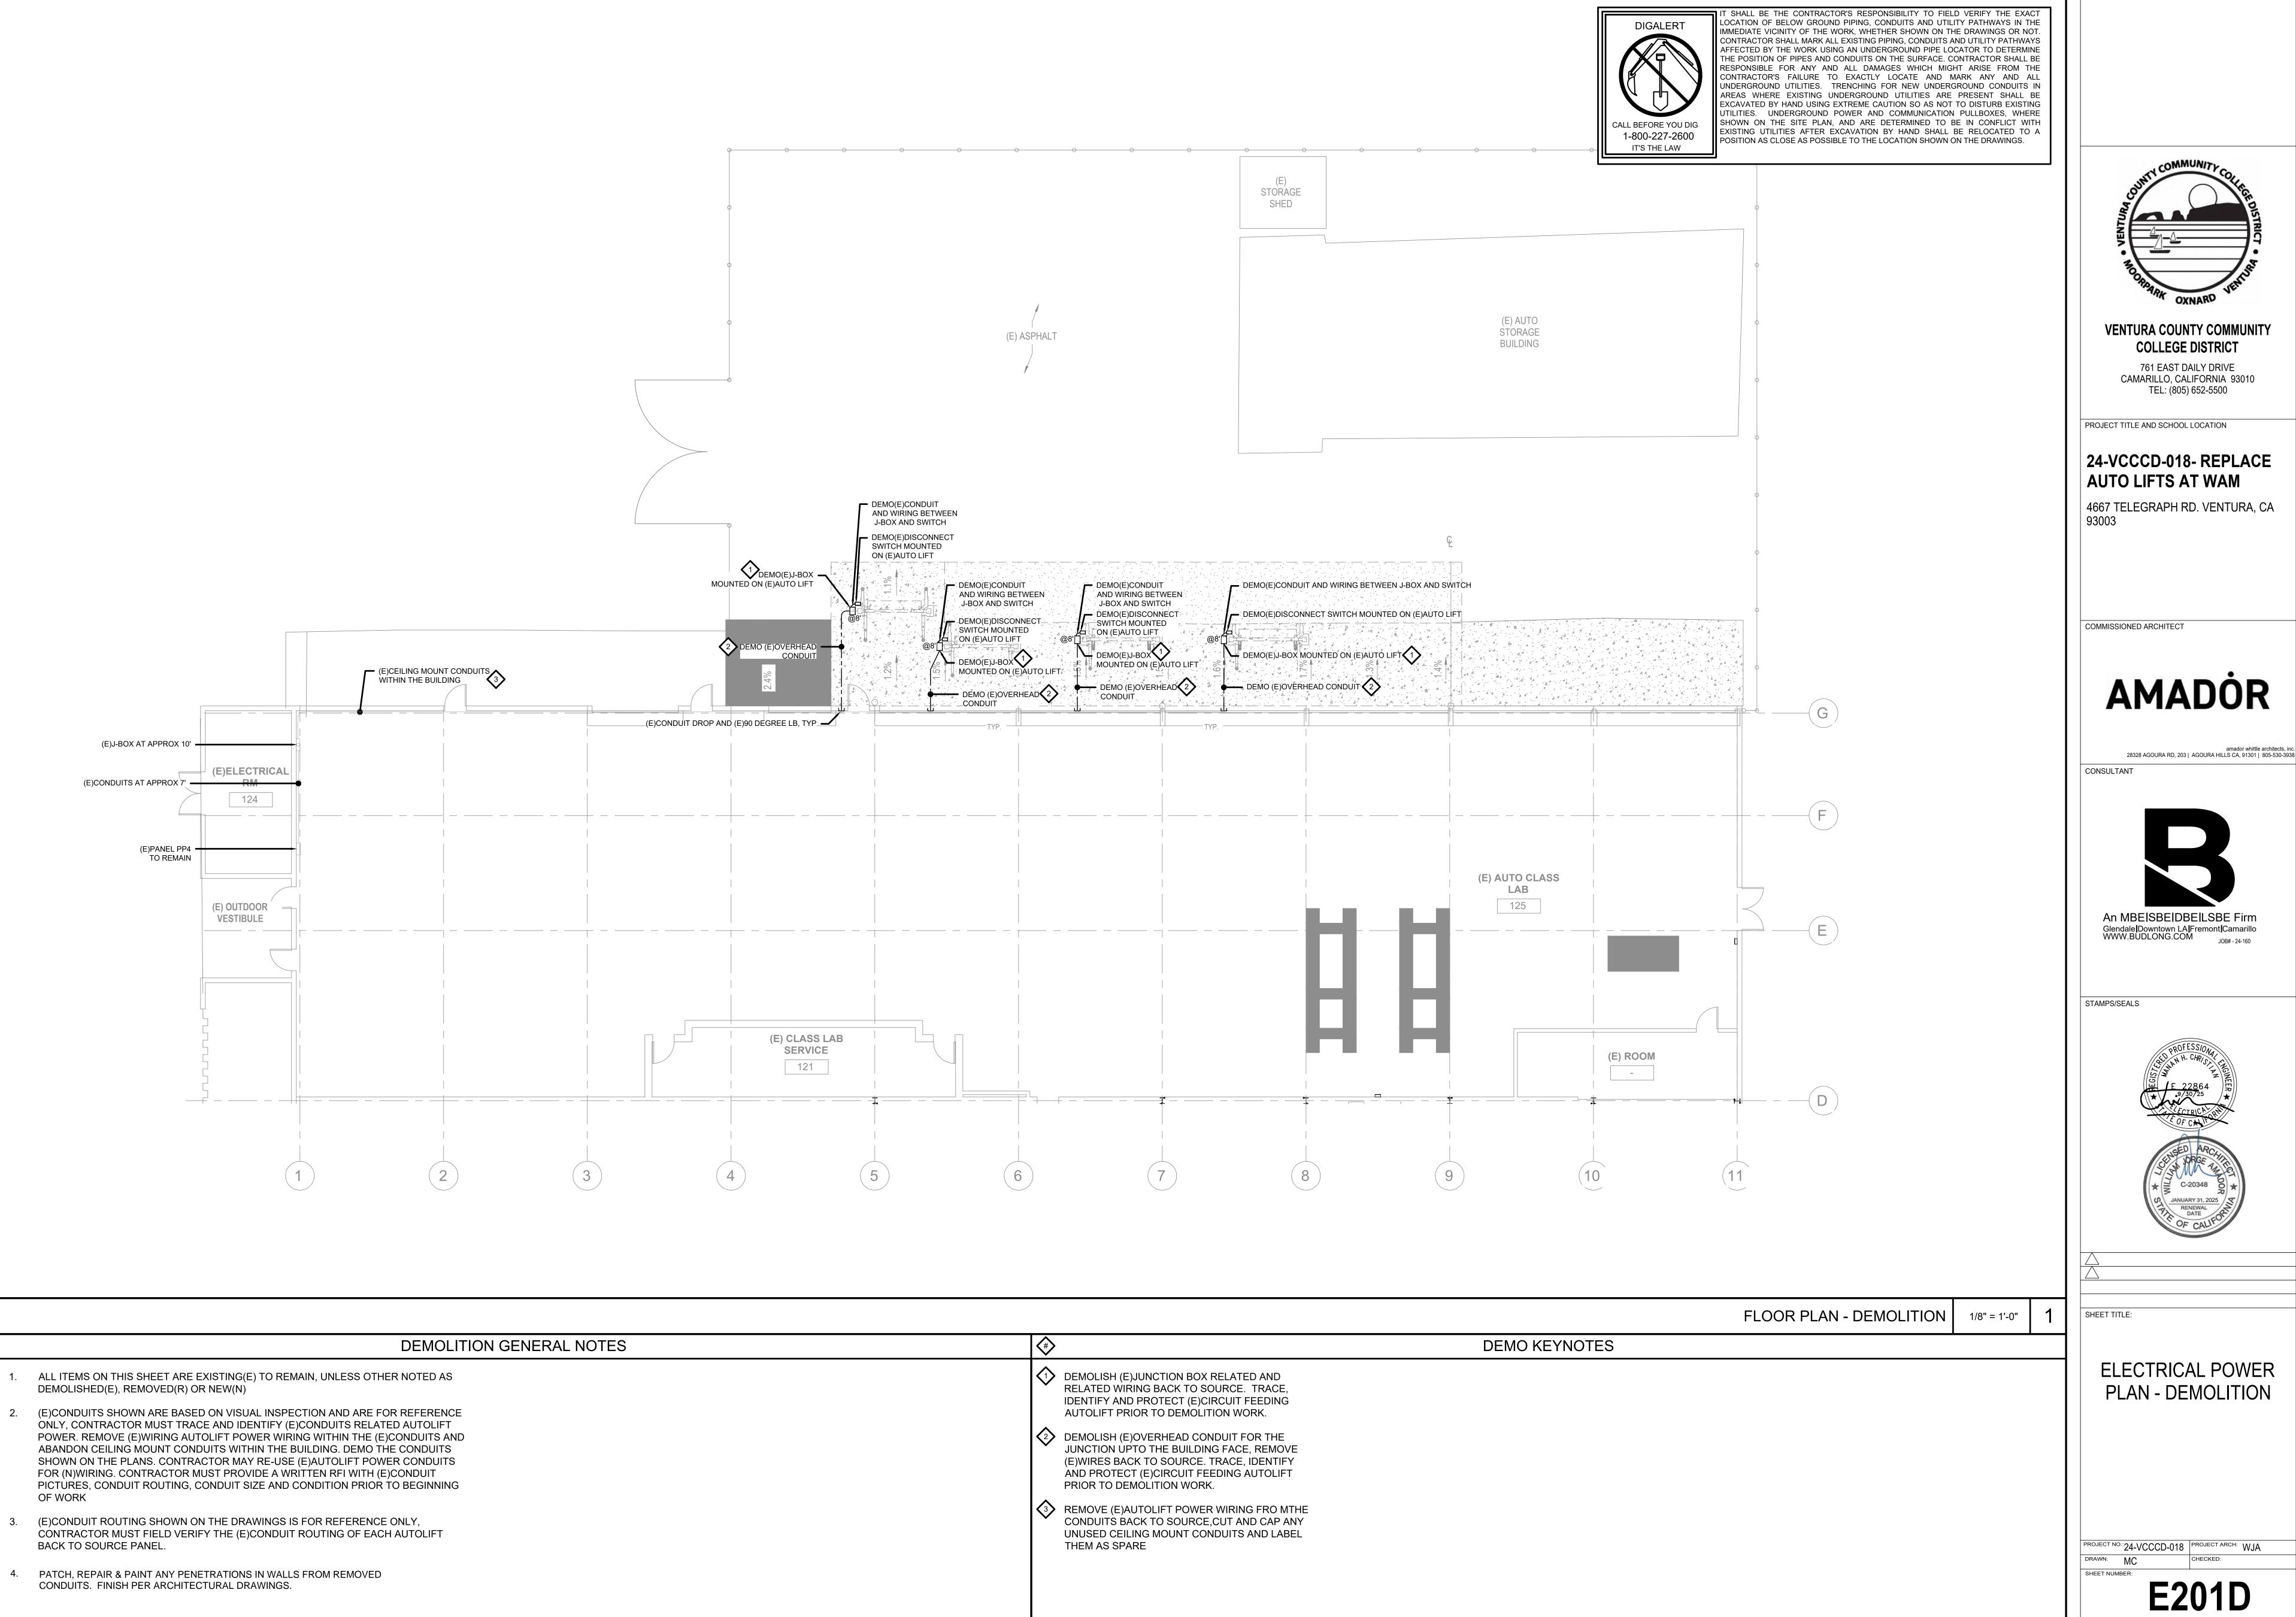

DIVISION OF THE STATE ARCHITECT



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24-VCCCD-018- REPLACE

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PLAN - DEMOLITION


PROJECT NO.:24-VCCCD-018 PROJECT ARCH: WJA

8/15/2024



IT SHALL BE THE CONTRACTOR'S RESPONSIBILITY TO FIELD VERIFY THE EXACT LOCATION OF BELOW GROUND PIPING, CONDUITS AND UTILITY PATHWAYS IN THE IMMEDIATE VICINITY OF THE WORK, WHETHER SHOWN ON THE DRAWINGS OR NOT. CONTRACTOR SHALL MARK ALL EXISTING PIPING, CONDUITS AND UTILITY PATHWAYS AFFECTED BY THE WORK USING AN UNDERGROUND PIPE LOCATOR TO DETERMINE THE POSITION OF PIPES AND CONDUITS ON THE SURFACE. CONTRACTOR SHALL BE RESPONSIBLE FOR ANY AND ALL DAMAGES WHICH MIGHT ARISE FROM THE CONTRACTOR'S FAILURE TO EXACTLY LOCATE AND MARK ANY AND ALL UNDERGROUND UTILITIES. TRENCHING FOR NEW UNDERGROUND CONDUITS IN AREAS WHERE EXISTING UNDERGROUND UTILITIES ARE PRESENT SHALL BE EXCAVATED BY HAND USING EXTREME CAUTION SO AS NOT TO DISTURB EXISTING UTILITIES. UNDERGROUND POWER AND COMMUNICATION PULLBOXES, WHERE SHOWN ON THE SITE PLAN, AND ARE DETERMINED TO BE IN CONFLICT WITH EXISTING UTILITIES AFTER EXCAVATION BY HAND SHALL BE RELOCATED TO A POSITION AS CLOSE AS POSSIBLE TO THE LOCATION SHOWN ON THE DRAWINGS.

FEED : TOP MOUNTING : SURFACE MOUNT			MA	IN BR	KR	AIC : N	N/A						M/	AIN: N	1L			
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FLOOR PLAN - NEW 1/8" = 1'-0" **GENERAL NOTES** RECONSTRUCTION KEYNOTES ALL ITEMS ON THIS SHEET ARE NEW(N) UNLESS OTHERWISE NOTED AS EXISTING(E) PROVIDE (N)CONDUIT DROP FROM (E)LB UP TO CIRCUITS SHOWN ON THE PLANS ARE BASED ON THE PERFORMED SITE VISIT, THE (E)DOOR LEVEL. CONTRACTOR MUST PROVIDE A WRITTEN RFI IF THE CIRCUITS SHOWN ON THE PLANS ARE DIFFERENT THAN (E)CIRCUITS TRACED AND IDENTIFIED PRIOR TO DEMO WORK 2 RECONNECT (N)DISCONNECT SWITCH TO 2. CONTRACTOR MAY RE-USE EXISTING CONDUITS IN FIELD FOR THE PROJECT. CONTRACTOR MUST PROVIDE A WRITTEN RFI WITH (E)CONDUIT PICTURES, CONDUIT (E)CIRCUIT IDENTIFIED PRIOR TO DEMO WORK. 9. ALL CONDUCTORS TO BE COPPER WITH MINIMUM 75 DEGREE RATING INSULATION, ROUTING AND CONDITION PRIOR TO BEGINNING OF WORK RATED FOR MINIMUM 600VAC 3. PROVIDE STRUCTURAL, SUPPORTS, BRACINGS, BACKINGS AS REQUIRED FOR ALL 10. ALL UNDERGROUND CONDUIT COVER DEPTH SHALL BE PER NEC TABLE 300.5. ELECTRICAL EQ, CONDUITS 11. PROVIDE CONDUIT BENDS AROUND EXISTING DOWNSPOUTS WHERE OCCURS. 4. MAINTAIN CODE REQUIRED WORKING CLEARANCE FOR ALL ELECTRICAL EQ. ALL ELECTRICAL EQ. LOCATED OUTSIDE OR ON EXTERIOR SHALL BE OFF NEMA-3R TYPE AND SHALL BE PROVIDED WITH WEATHERPROOF COVER
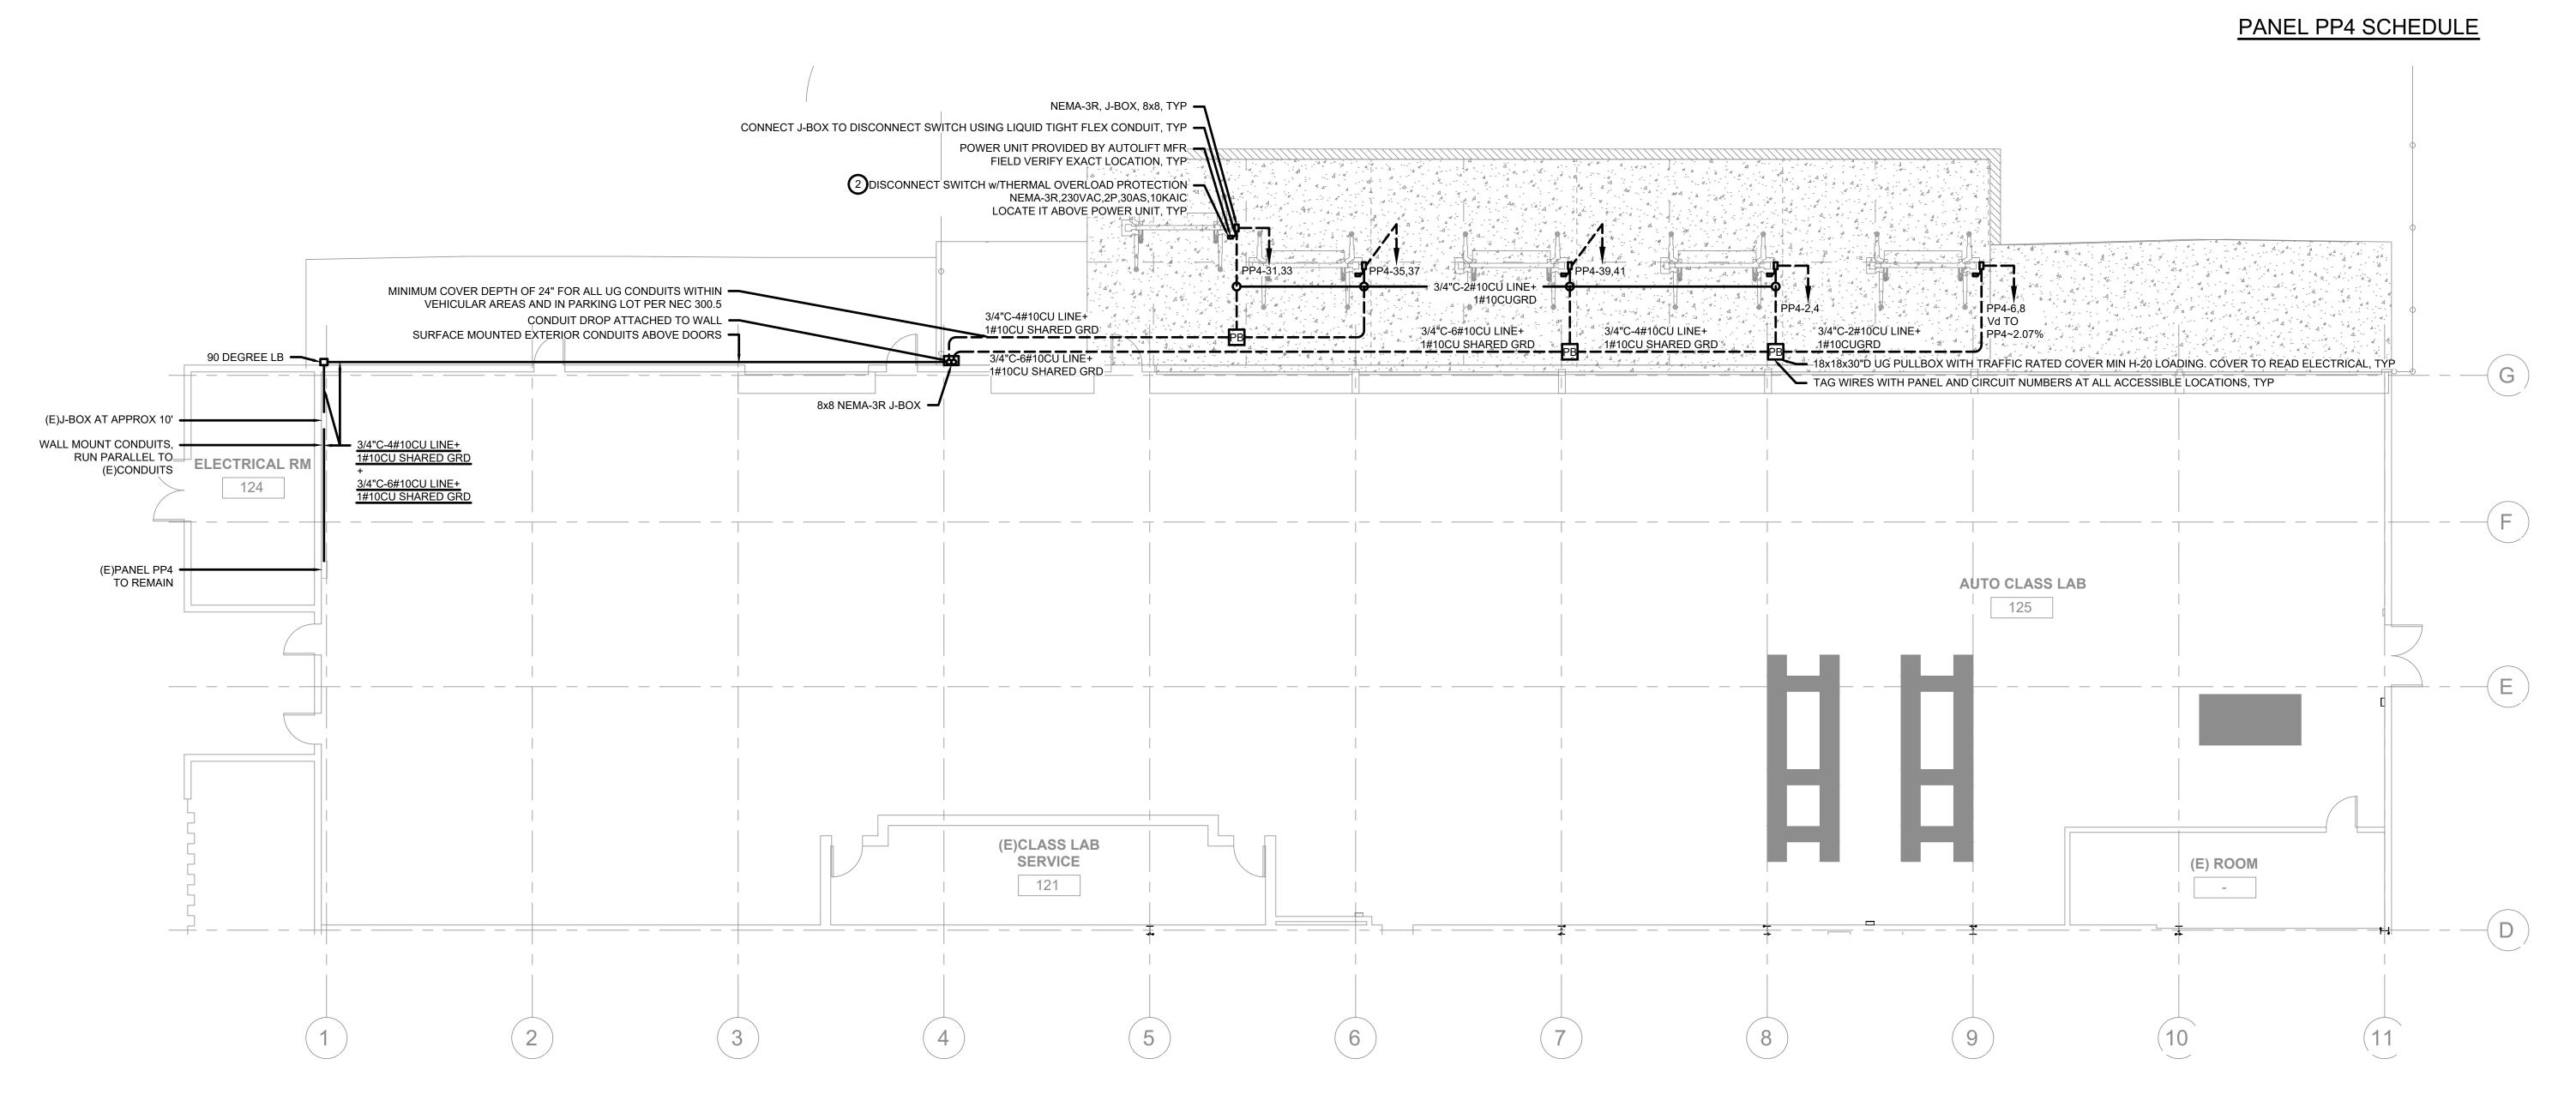
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COMMISSIONED ARCHITECT

AMADOR

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Glendale Downtown LA Fremont Camarillo
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JOB# - 24-160

STAMPS/SEALS



SHEET TITLE:

ELECTRICAL POWER PLAN - NEW

PROJECT NO.:24-VCCCD-018 PROJECT ARCH: WJA

SHEET NUMBER:

E201

DATE: 8/15/2024

SHEET: ____ OF

dor Ventura CC WAM - Outdoor Rack RPLC

6. USE PVC SCH40. FOR UNDERGROUND CONDUITS, EMT FOR INTERIOR EXPOSED,

OTHER FITTINGS SHALL BE COMPATIBLE WITH CONDUIT MATERIALS

CONCEALED CONDUITS, RGS FOR EXTERIOR EXPOSED CONDUITS. LBs OR ANY

LABEL/TAG ALL ELECTRICAL EQ. INCLUDING BUT NOT LIMITED TO DISCONNECTS, SWITCHES, PANELS, TRANSFORMERS THAT ARE WITHIN THE SCOPE OF WORK

